| DRAWING NUMBER         | DRAWING TITLE   | REVISION |
|------------------------|---|----------|
| 7061520-INDEX-PIII-001 | DRAWING INDEX   | Α        |
| 7061520-LAP-001-012    | PROJECT LOCATION MAP  | А        |
| 7061520-TCS-002-002    | TYPICAL CROSS SECTION (SHEET 2)   | Α        |
| 7061520-TCS-002-003    | TYPICAL CROSS SECTION (SHEET 3)   | Α        |
| 7061520-TCS-002-004    | TYPICAL CROSS SECTION (SHEET 4)   | Α        |
| 7061520-TCS-002-005    | TYPICAL CROSS SECTION (SHEET 5)   | Α        |
| 7061520-TCS-002-005A   | TYPICAL CROSS SECTION (SHEET 6)   | Α        |
| 7061520-TCS-002-006    | TYPICAL CROSS SECTION (SHEET 7)   | Α        |
| 7061520-TCS-002-007    | TYPICAL CROSS SECTION BRIDGE  | Α        |
| 7061520-TCS-002-011    | TYPICAL WALL DETAIL   | Α        |
| 7061520-TCS-002-012    | TYPICAL SECTION OF AVALANCHE PROTECTION MEASURES                                  | Α        |
| 7061520-TCS-002-013    | TYPICAL CROSS SECTION SCHEDULE  | Α        |
| 7061520-APS-002-001    | PRECAST ARCHED TYPE CUT & COVER TYPICAL CROSS SECTION & DETAILS                   | Α        |
| 7061520-APS-002-002    | FINAL LINING REINFORCEMENT CUT & COVER (OPTION) TYPICAL CROSS SECTION & DETAILS   | Α        |
| 7061520-APS-002-003    | STRUT SUPPORTED SOLDIER PILES SECTIONS & DETAILS                                  | Α        |
| 7061520-APS-002-004    | AVALANCHE PROTECTION STRUCTURE SNOW GALLERY IN STRAIGHT FOUNDATION PLAN & DETAIL  | А        |
| 7061520-APS-002-005    | AVALANCHE PROTECTION STRUCTURE SNOW GALLERY IN STRAIGHT BEAM LAYOUT PLAN & DETAIL | Α        |
| 7061520-APS-002-006    | AVALANCHE PROTECTION STRUCTURE SNOW GALLERY IN CURVE GRID LAYOUT PLAN             | Α        |
| 7061520-APS-002-007    | AVALANCHE PROTECTION STRUCTURE SNOW GALLERY IN CURVE FOUNDATION PLAN & DETAIL     | Α        |
| 7061520-APS-002-008    | AVALANCHE PROTECTION STRUCTURE SNOW GALLERY IN CURVE BEAM LAYOUT PLAN & DETAIL    | Α        |
| 7061520-APS-002-009    | AVALANCHE PROTECTION STRUCTURE SNOW GALLERY CROSS SECTION DETAIL                  | А        |
| PLAN AND PROFILE       |   |          |
| 7061520-P&P-004-010A   | PLAN AND PROFILE FROM KM. 9+760 TO 10+000   | Α        |
| 7061520-P&P-004-011    | PLAN AND PROFILE FROM KM. 10+000 TO 11+000  | Α        |
| 7061520-P&P-004-012    | PLAN AND PROFILE FROM KM. 11+000 TO 12+000  | Α        |
| 7061520-P&P-004-013    | PLAN AND PROFILE FROM KM. 12+000 TO 13+000  | Α        |
| 7061520-P&P-004-014    | PLAN AND PROFILE FROM KM. 13+000 TO 14+000  | Α        |
| 7061520-P&P-004-015    | PLAN AND PROFILE FROM KM. 14+000 TO 15+000  | Α        |
| 7061520-P&P-004-016    | PLAN AND PROFILE FROM KM. 15+000 TO 16+000  | Α        |
| 7061520-P&P-004-017    | PLAN AND PROFILE FROM KM. 16+000 TO 17+000  | А        |
| 7061520-P&P-004-018    | PLAN AND PROFILE FROM KM. 17+000 TO 17+817  | А        |
| 7061520-P&P-004-019    | APPROACH ROAD 2 (MINAMARG) PLAN AND PROFILE FROM KM. 0+000 TO 0+660               | А        |
| 7061520-P&P-004-020B   | HORIZANTAL ALIGNMENT REPORT   | А        |
| 7061520-P&P-004-021B   | VERTICAL ALIGNMENT REPORT   | А        |

O.\Zojila\H - Deliverables\H2 - CADD\DWG\DWG\DWG\DWG\DOT\_General\7061520-INDEX-PIII-001\_[A].dwg

DESIGNER

| Member | SMEC (India) Pv. |
Novus Tower, West W. |
Sector - 18, Gurgaoi
| DRAWN | DESIGN |
DRAWN | DESIGN |
RT | RK

DESIGNER

SMEC (India) Pvt Ltd. 1st Floor,
Novus Tower, West Wing, Plot Number -18,
Sector -18, Gurgaon - 122015, Haryana

DRAWN DESIGN CHECKED APPROVED
BT RK MP NA CHECKED APPROVED

BT RK MP NA DATE

CLIENT

LUISIN MARKSTRUCTURE BULDING THE MATON

NATIONAL HIGHWAYS & INFRASTRUCTURE DEVELOPMENT
CORPORATION LTD. PTI BUILDING . 4 PARLIAMENT STREET,
SANSAD MARG AREA, NEW DELHI- 110001

APPROVED DATE


CONSTRUCTION OF APPROACH ROADS TO EAST AND
WEST PORTAL OF PROPOSED ZOJILA TUNNEL
WITH AVALANCHE PROTECTION WORKS
IN THE UT OF JAMMU & KASHMIR AND LADAKH


DRAWING INDEX

AWING STATUS
INDER

PROJECT / DRAWING No.
7061520-INDEX-PIII-001 A


06 Mar 2020 15:02:26

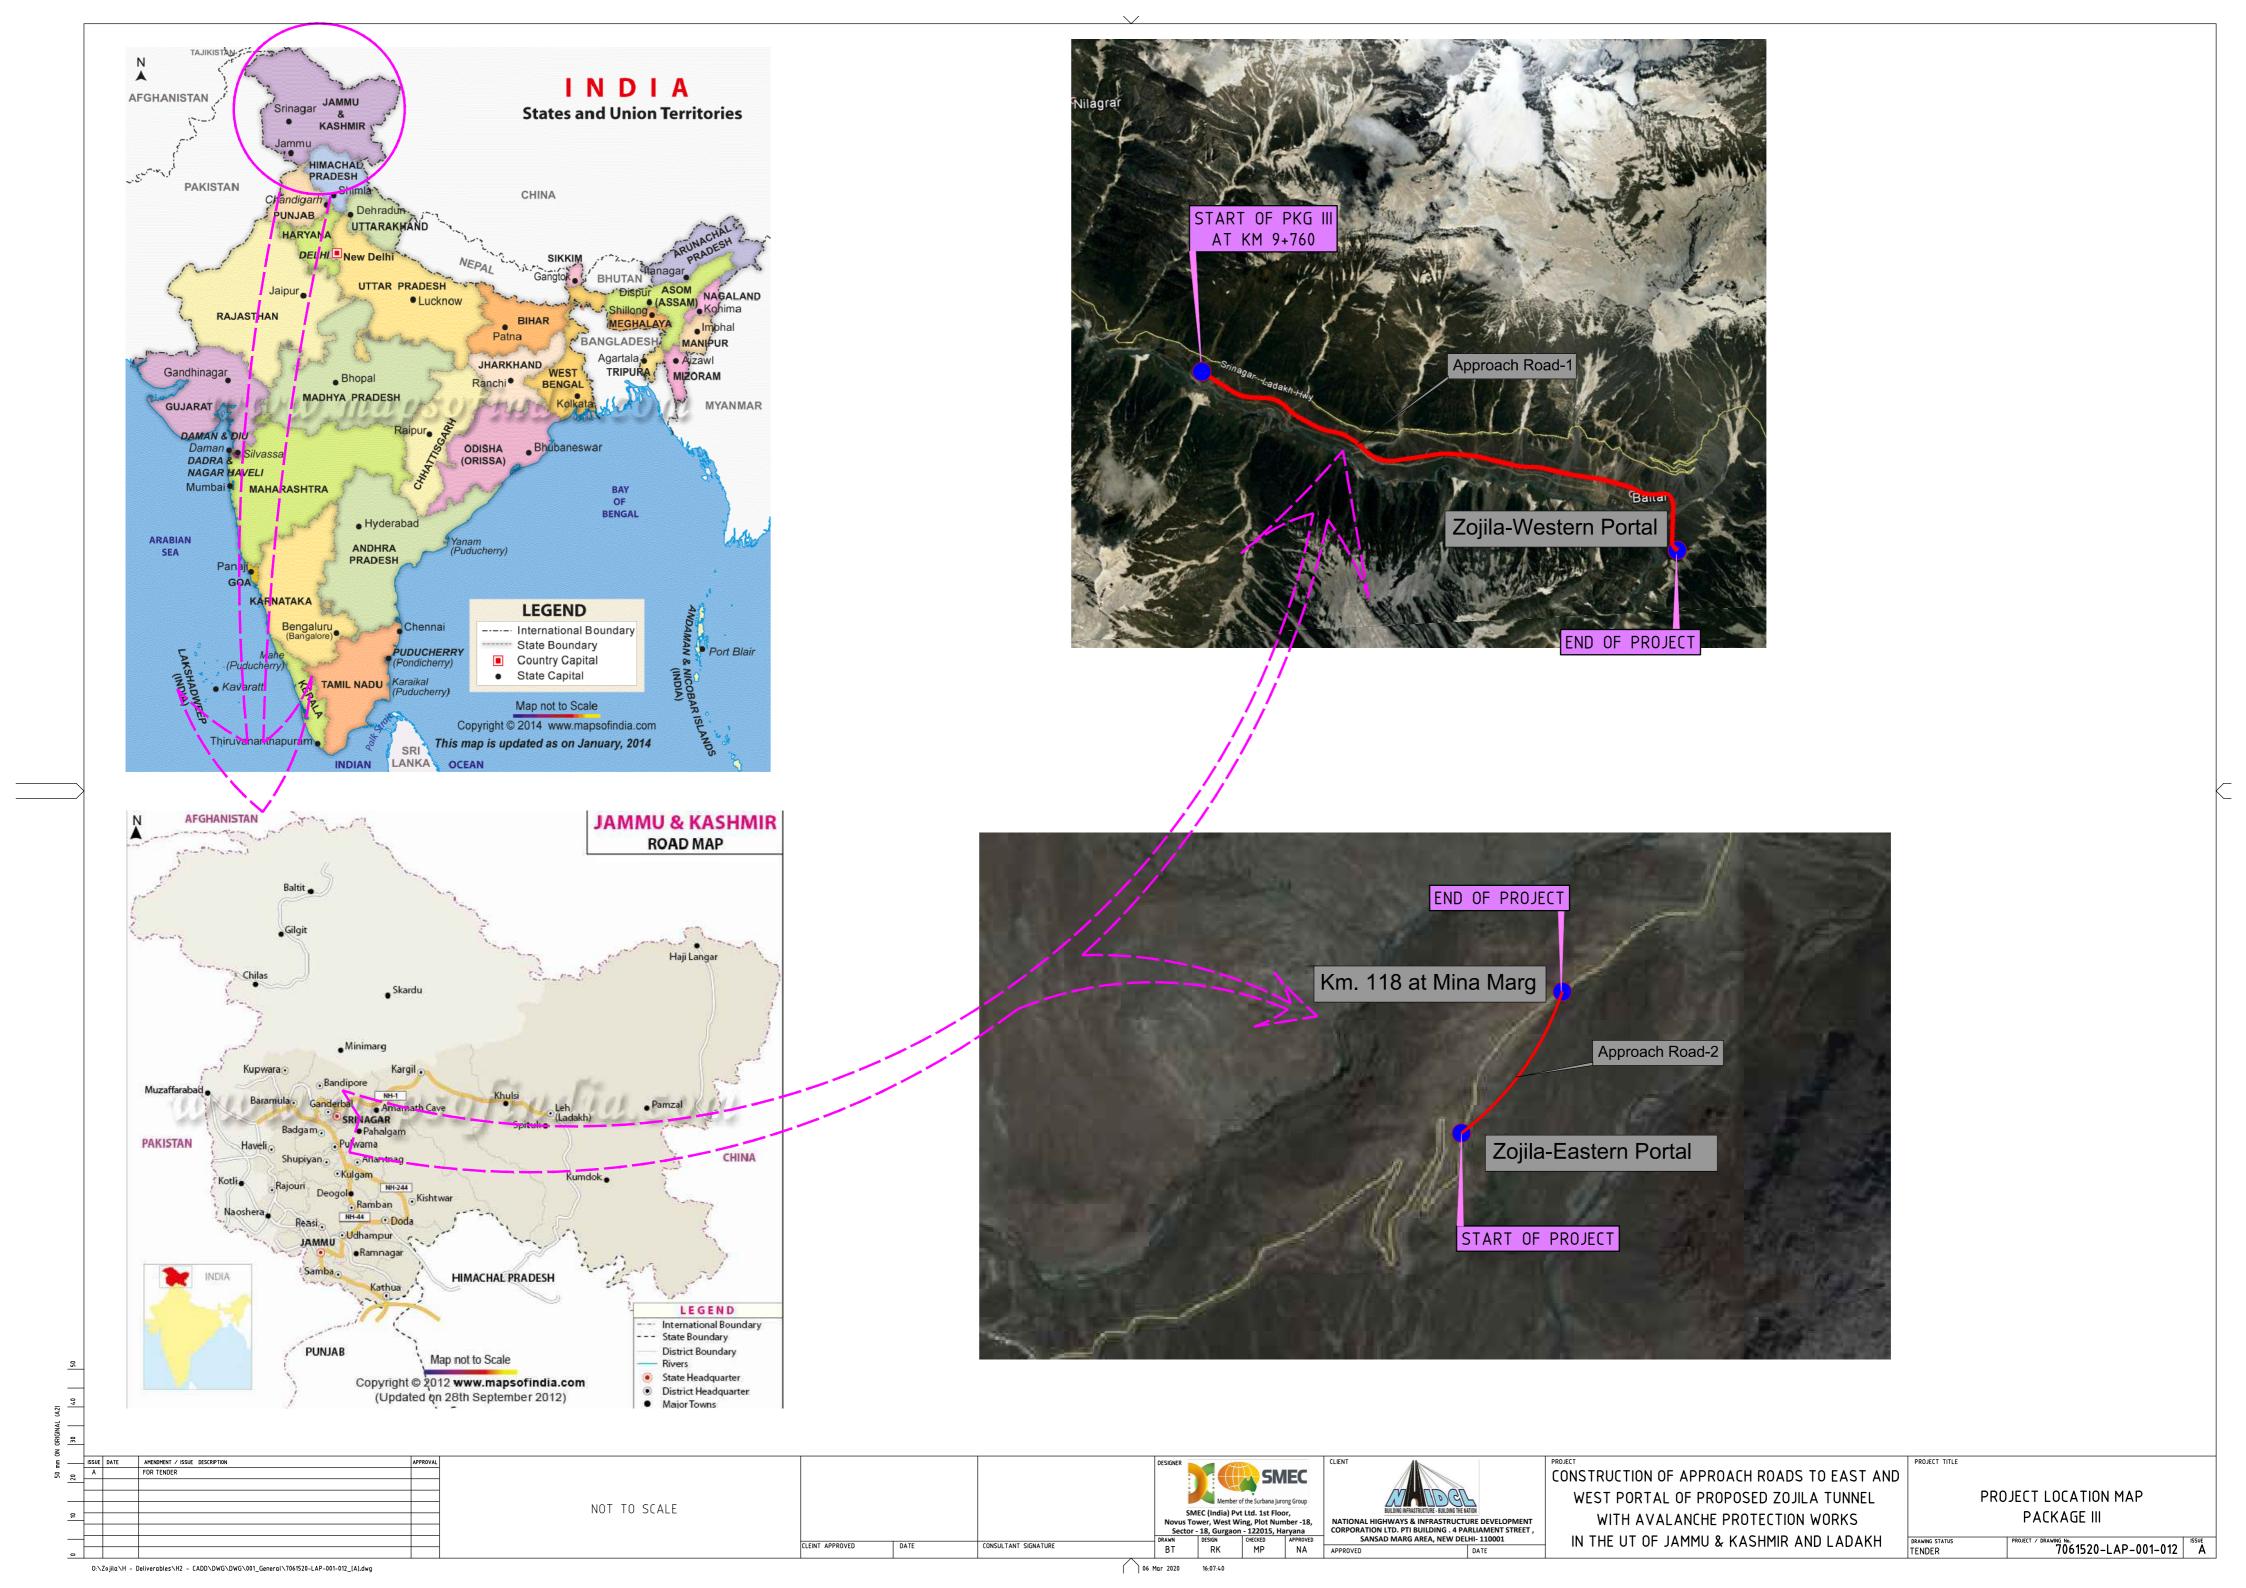


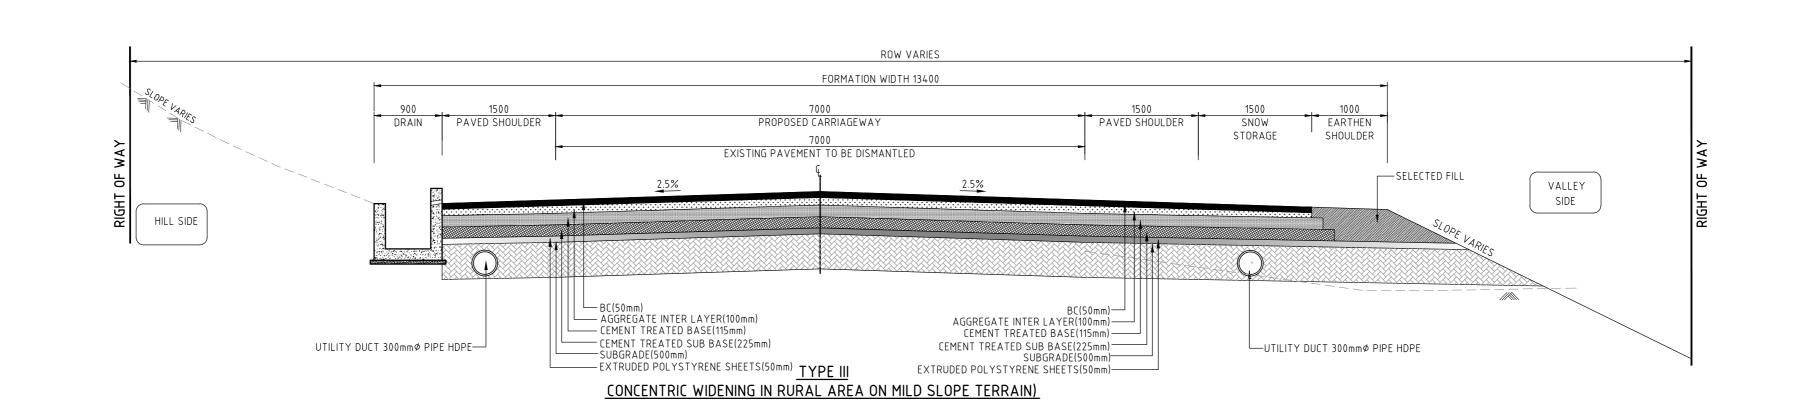

- 1. EXTRA WIDENING SHALL BE REFERED AS PER IRC-SP 48 1998,IRC-SP 73 2015 & IRC 52 2001 AT CURVE LOCATIONS WITH RADIUS LESS THAN 300m. SLOPE TREATMENT SHOWN ON HILL/VALLEY SLOPES ARE INDICATIVE AND MAY VARY BASED ON CONFIRMATORY GEO TECHNICAL INVESTIGATION AND GEOLOGICAL STUDY
- THE TYPE OF PROTECTION MATERIAL FOR RETAINING WALL, BREAST WALL MAY BE CHANGED BASED ON SITE REQUIREMENT.
- 4. AS PER IRC-SP 48 1998, CLAUSE NO 6.5.2(4), ON ROADS SUBJECTED TO HEAVY SNOWFALL, WHERE SNOW CLEARANCE IS DONE OVER LONG PERIODS, ROADWAY WIDTH MAY BE INCREASED BY 1.5M. HOWEVER THE REQUIREMENT OF SUCH WIDENING MAY BE EXAMINED WITH REFERENCE TO GROUND CONDITIONS IN EACH CASE CONSIDERING TERRAIN, TRAFFIC AND OTHER INFLUENCING CONDITIONS/FACTORS

5. DEPTH OF CONSTRUCTION (PAVEMENT) SHOULD NOT BE LESS THAN DEPTH OF FROST PENETRATION AND SHOULD COMPOSE OF NON-FROST SUSCEPTIBLE MATERIAL, IN ANY CASE THE THICKNESS SHOULD NOT BE LESS THAN 45cm AS PER IRC:SP:48:1998. ISSUE DATE AMENDMENT / ISSUE DESCRIPTION
A FOR TENDER SCALES AT A2 SIZE DRAWING SMEC CONSTRUCTION OF APPROACH ROADS TO EAST AND HORIZ. 1:50 0.50 0 0.50 1.00 1.50 2.00 2.50m WEST PORTAL OF PROPOSED ZOJILA TUNNEL TYPICAL CROSS SECTION SMEC (India) Pvt Ltd. 1st Floor, (SHEET 2) WITH AVALANCHE PROTECTION WORKS NATIONAL HIGHWAYS & INFRASTRUCTURE DEVELOPMENT CORPORATION LTD. PTI BUILDING . 4 PARLIAMENT STREET , SANSAD MARG AREA, NEW DELHI- 110001 IN THE UT OF JAMMU & KASHMIR AND LADAKH 7061520-TCS-002-002 SSUE A CLEINT APPROVED CONSULTANT SIGNATURE  $0: \label{local_coss_sections} O: \label{local_coss_sections} PKG-3 \ \ 7061520-TCS-002-002\_[A]. dwg$ 

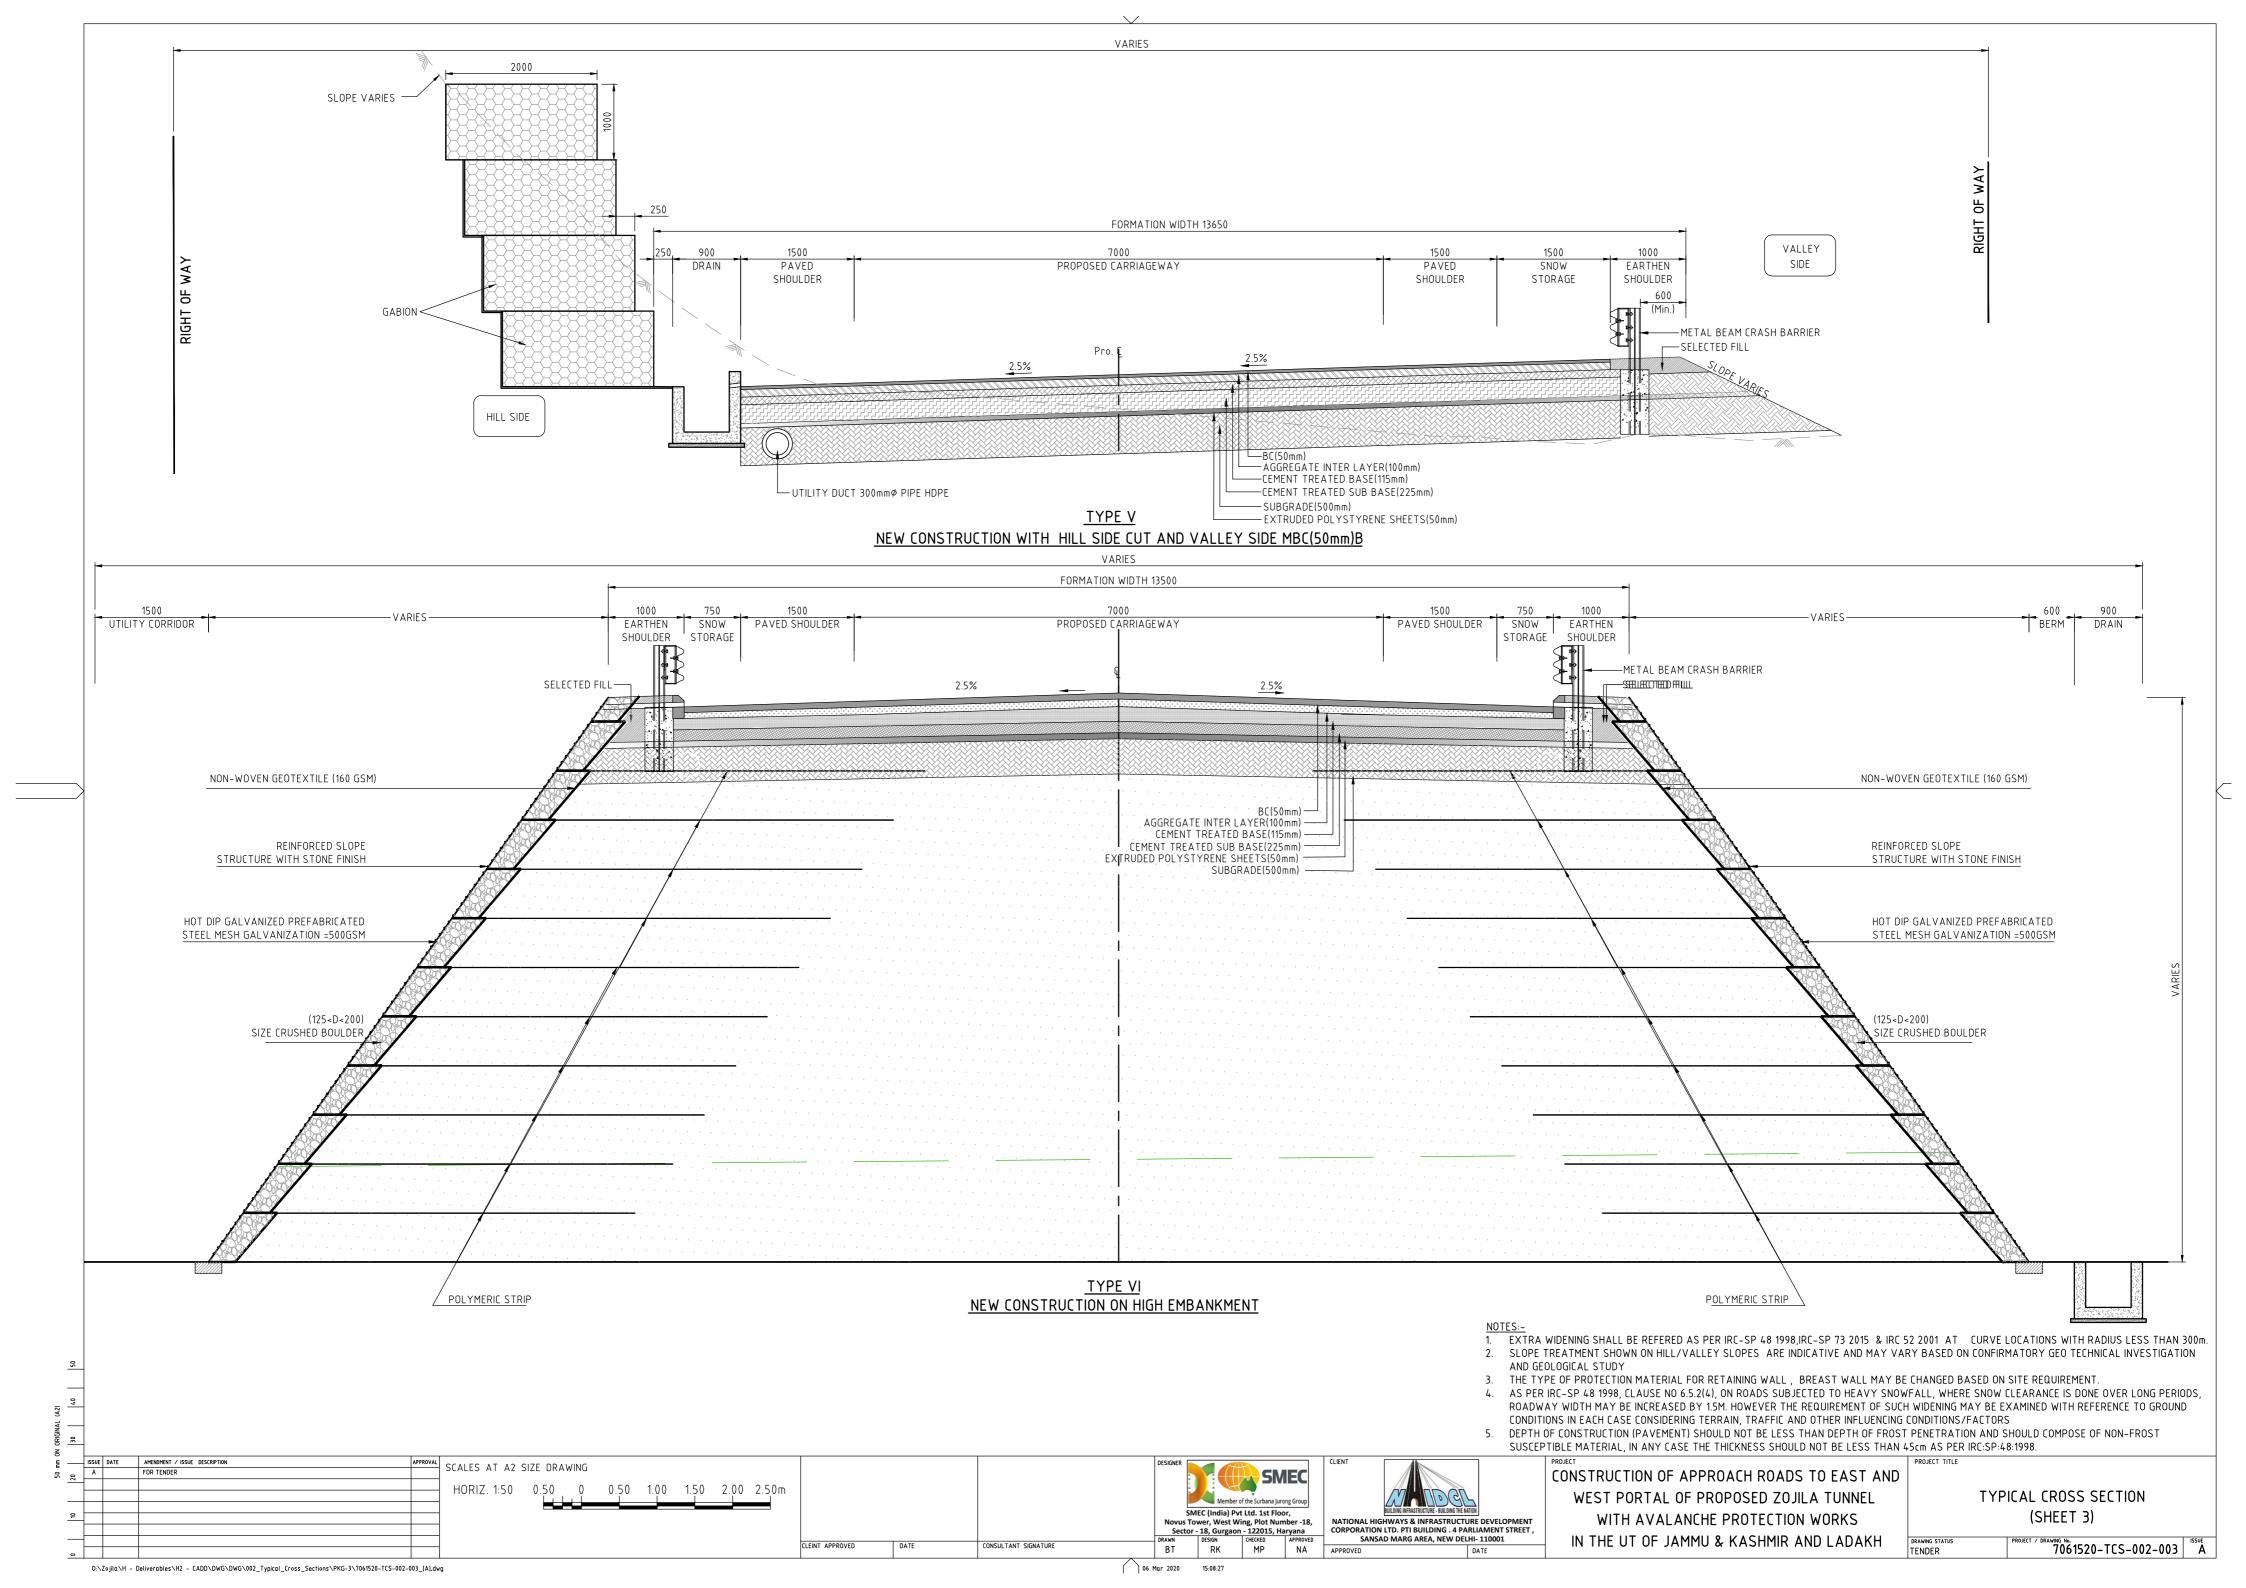

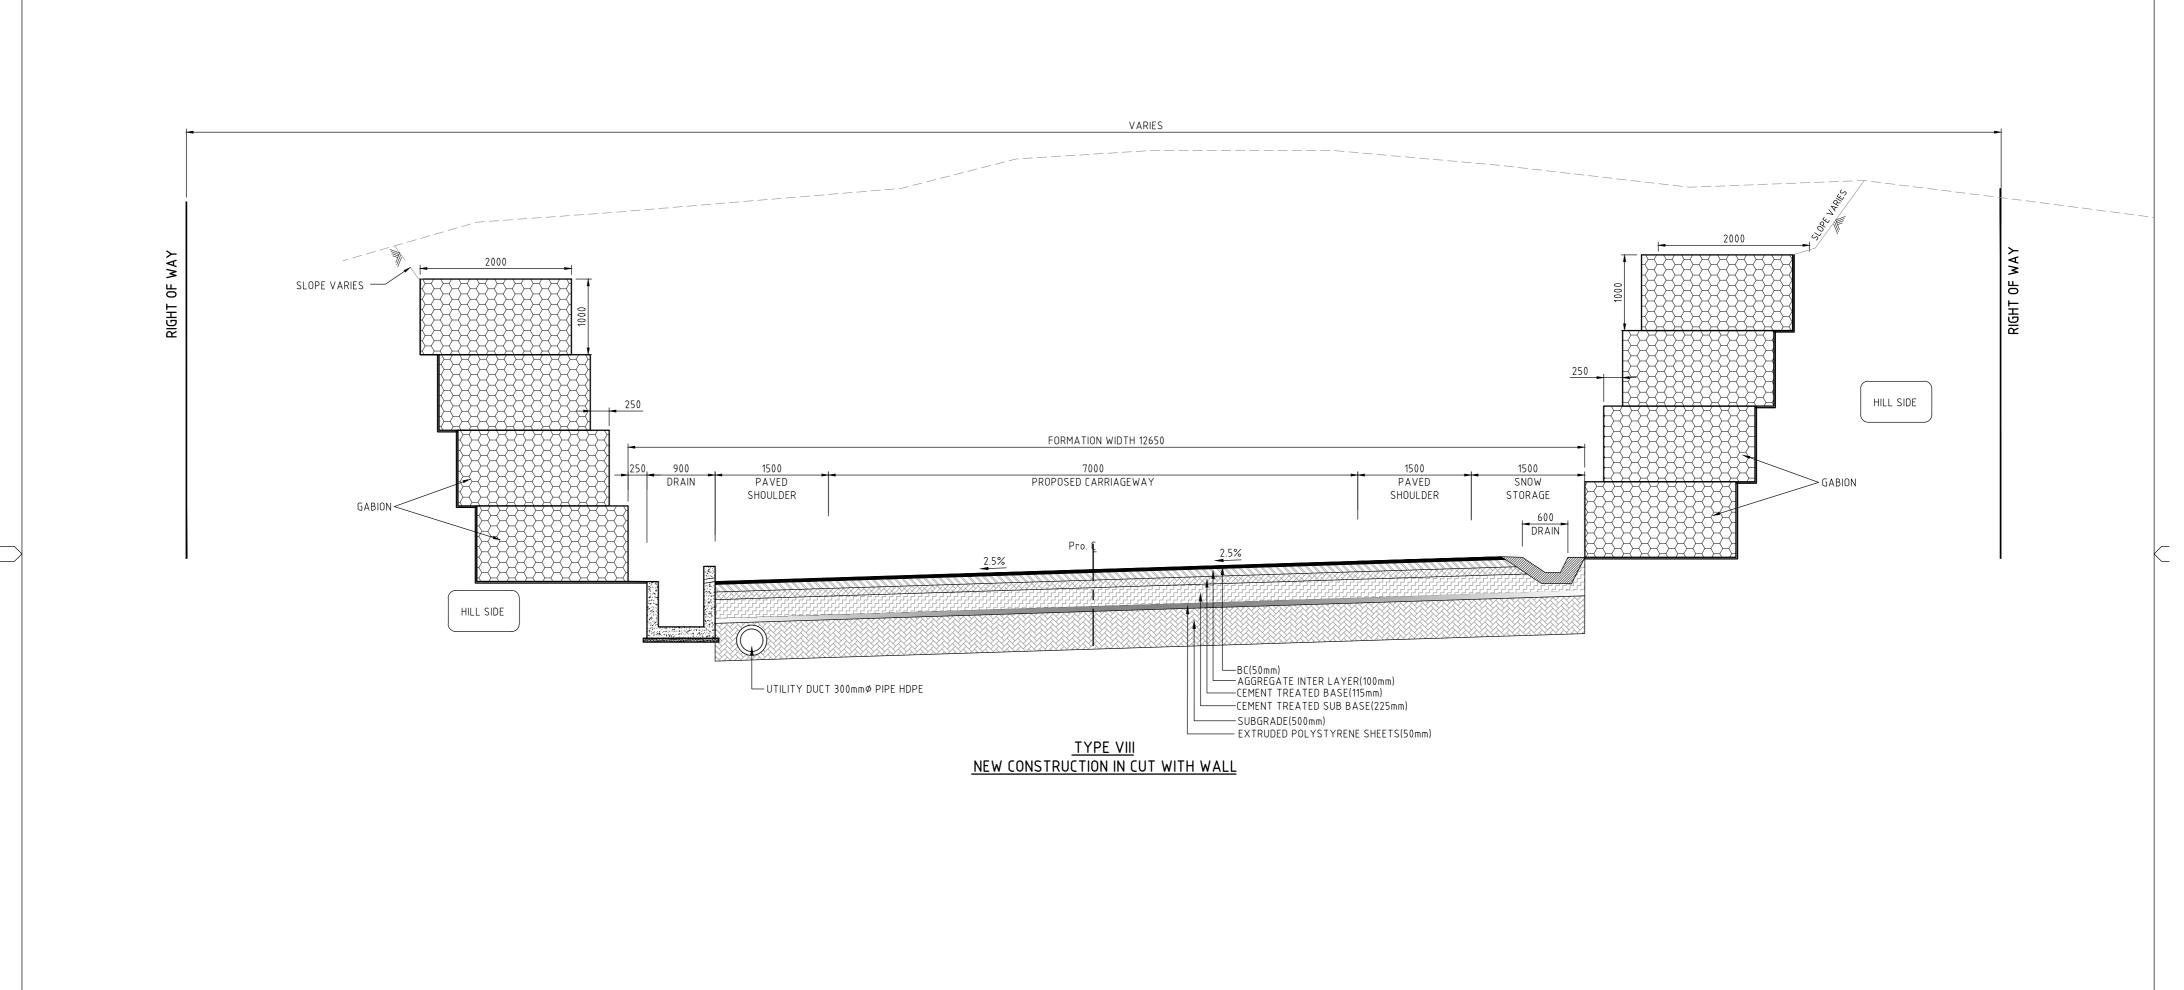

- 1. EXTRA WIDENING SHALL BE REFERED AS PER IRC-SP 48 1998,IRC-SP 73 2015 & IRC 52 2001 AT CURVE LOCATIONS WITH
- 2. SLOPE TREATMENT SHOWN ON HILL/VALLEY SLOPES ARE INDICATIVE AND MAY VARY BASED ON CONFIRMATORY GEO
- TECHNICAL INVESTIGATION AND GEOLOGICAL STUDY
- 3. THE TYPE OF PROTECTION MATERIAL FOR RETAINING WALL, BREAST WALL MAY BE CHANGED BASED ON SITE REQUIREMENT. 4. AS PER IRC-SP 48 1998, CLAUSE NO 6.5.2(4), ON ROADS SUBJECTED TO HEAVY SNOWFALL, WHERE SNOW CLEARANCE IS DONE OVER LONG PERIODS, ROADWAY WIDTH MAY BE INCREASED BY 1.5M. HOWEVER THE REQUIREMENT OF SUCH WIDENING MAY BE EXAMINED WITH REFERENCE TO GROUND CONDITIONS IN EACH CASE CONSIDERING TERRAIN, TRAFFIC AND OTHER INFLUENCING
- CONDITIONS/FACTORS 5. DEPTH OF CONSTRUCTION (PAVEMENT) SHOULD NOT BE LESS THAN DEPTH OF FROST PENETRATION AND SHOULD COMPOSE OF

NON-FROST SUSCEPTIBLE MATERIAL, IN ANY CASE THE THICKNESS SHOULD NOT BE LESS THAN 45cm AS PER IRC:SP:48:1998.

CONSTRUCTION OF APPROACH ROADS TO EAST AND


TYPICAL CROSS SECTION (SHEET 4) 7061520-TCS-002-004 A


ISSUE DATE AMENDMENT / ISSUE DESCRIPTION
A FOR TENDER SCALES AT A2 SIZE DRAWING SMEC HORIZ. 1:50 0.50 0 0.50 1.00 1.50 2.00 2.50m SMEC (India) Pvt Ltd. 1st Floor,
Novus Tower, West Wing, Plot Number -18,
Sector - 18, Gurgaon - 122015, Haryana

DRAWN DESIGN CHECKED APPROVED
PK CA MP NA APPROVED CLEINT APPROVED CONSULTANT SIGNATURE  $0: \label{local_coss_sections} O: \label{local_coss_sections} PKG-3 \ \ 7061520-TCS-002-004\_[A]. dwg$ 

NATIONAL HIGHWAYS & INFRASTRUCTURE DEVELOPMENT CORPORATION LTD. PTI BUILDING . 4 PARLIAMENT STREET , SANSAD MARG AREA, NEW DELHI- 110001

WEST PORTAL OF PROPOSED ZOJILA TUNNEL WITH AVALANCHE PROTECTION WORKS IN THE UT OF JAMMU & KASHMIR AND LADAKH

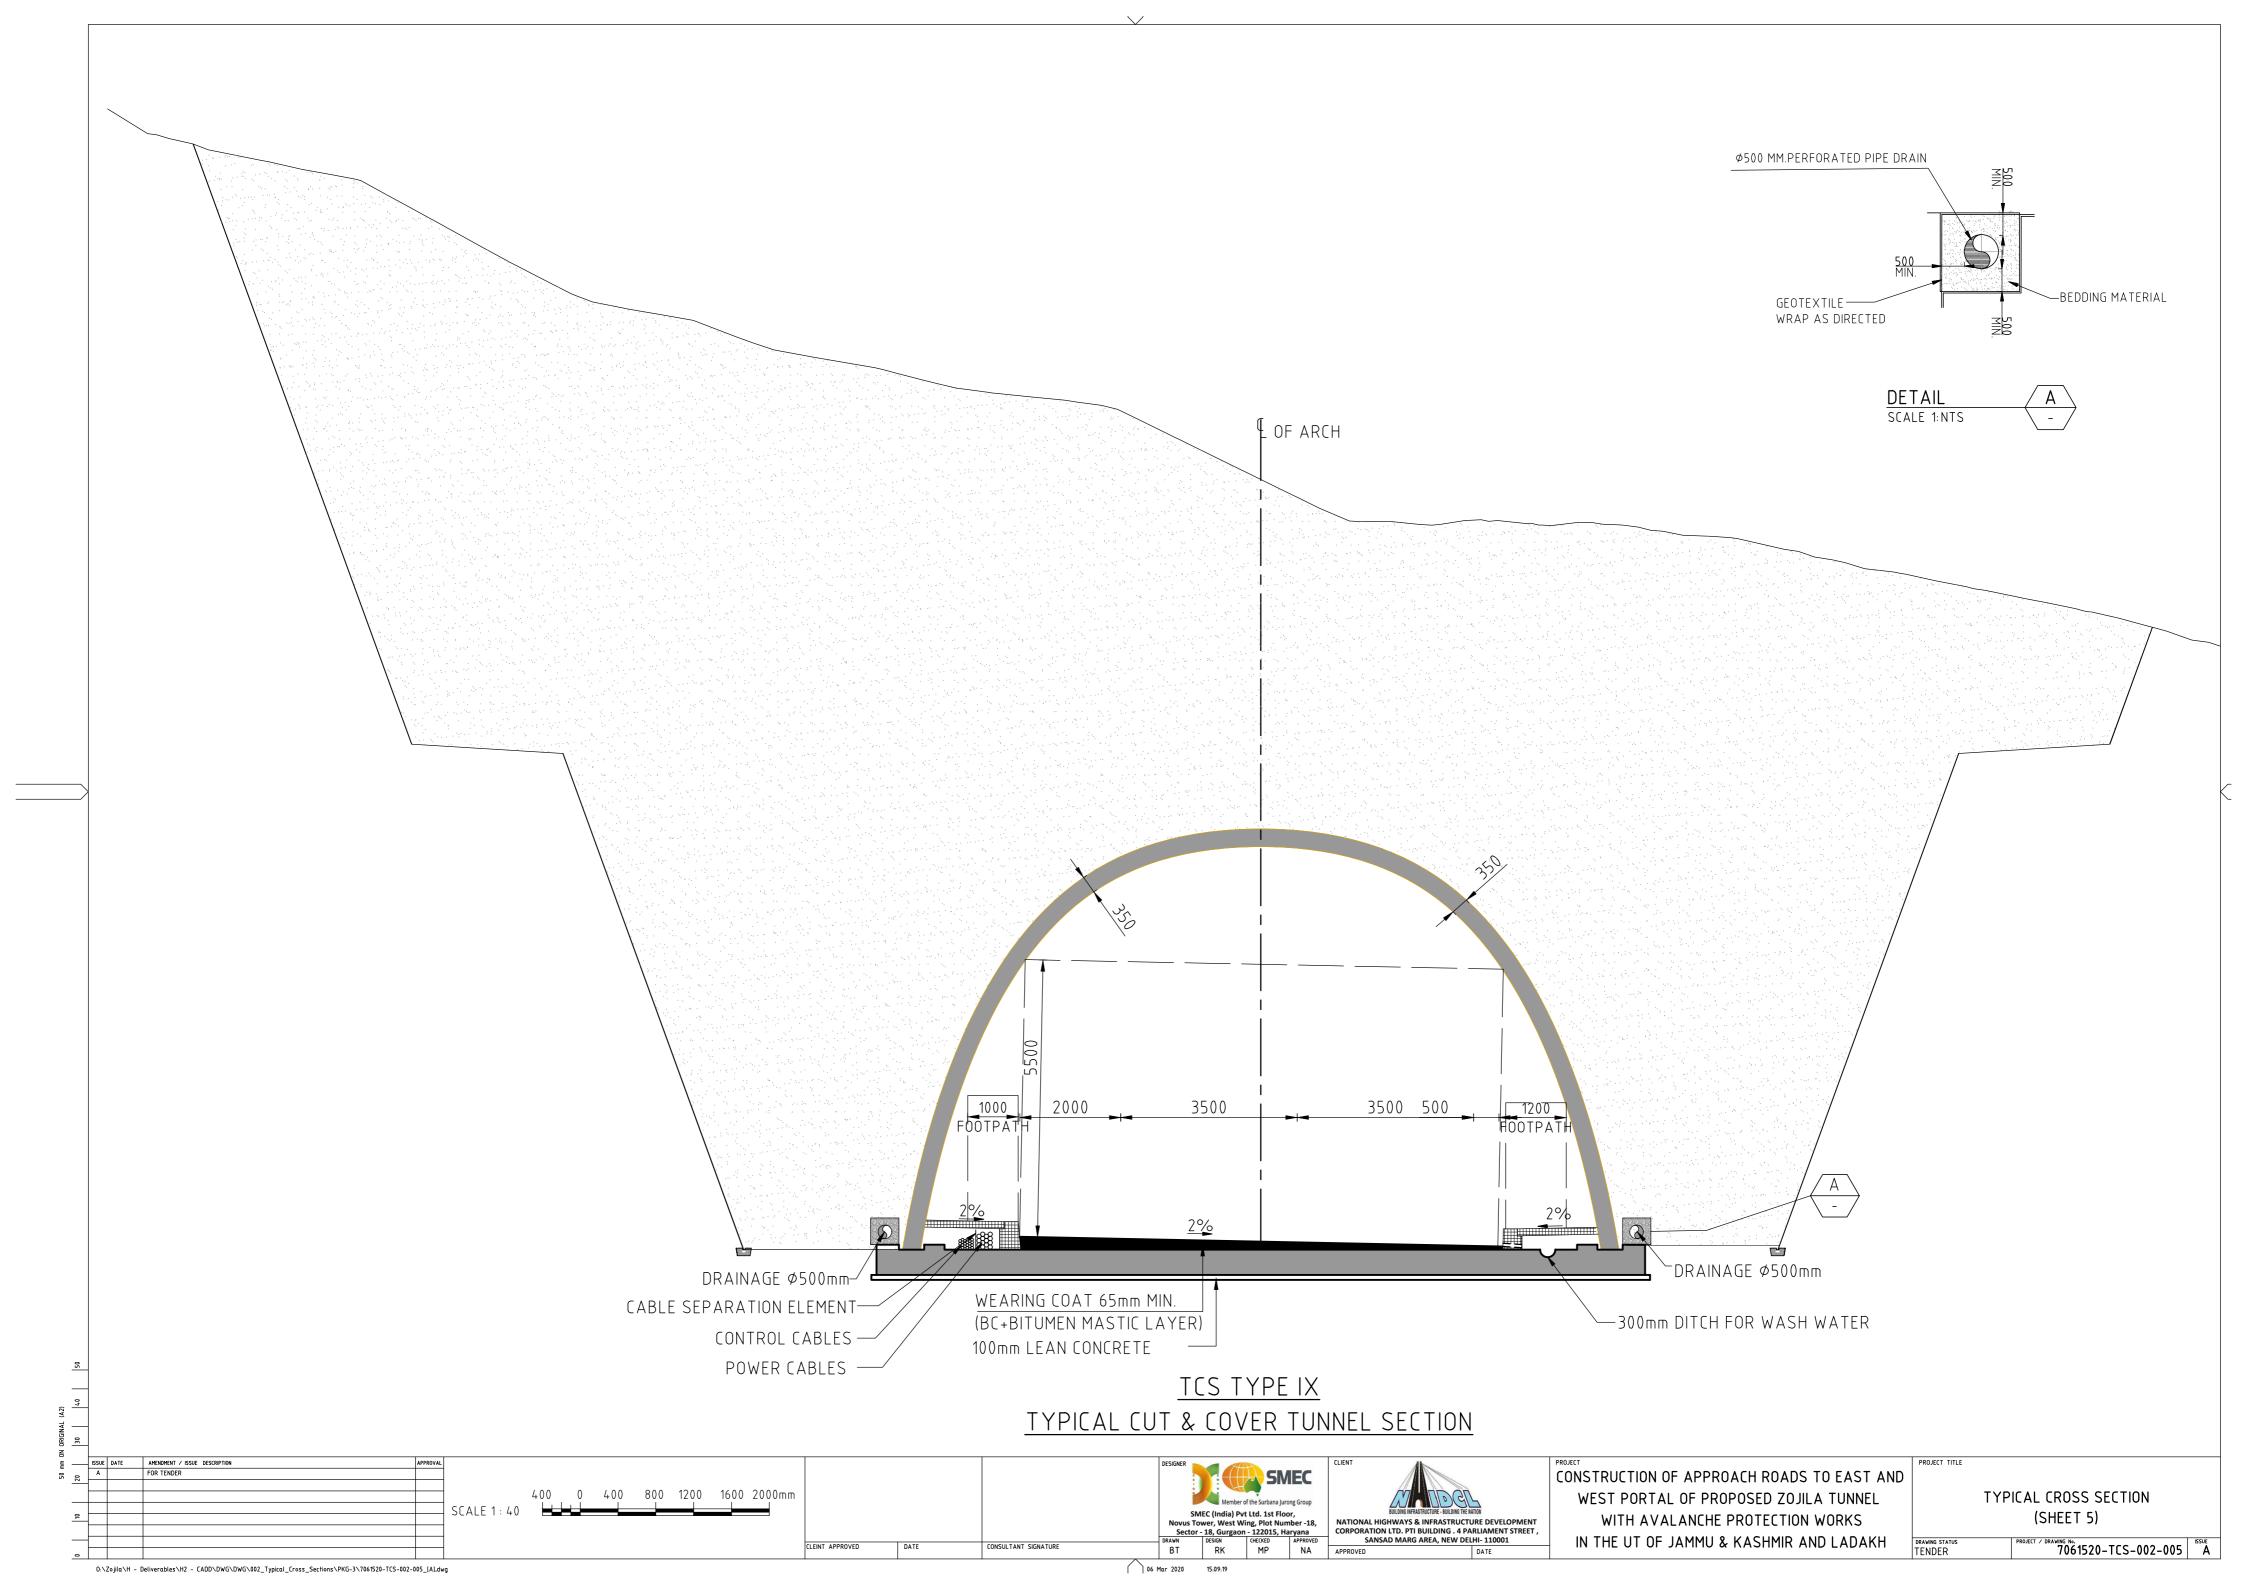

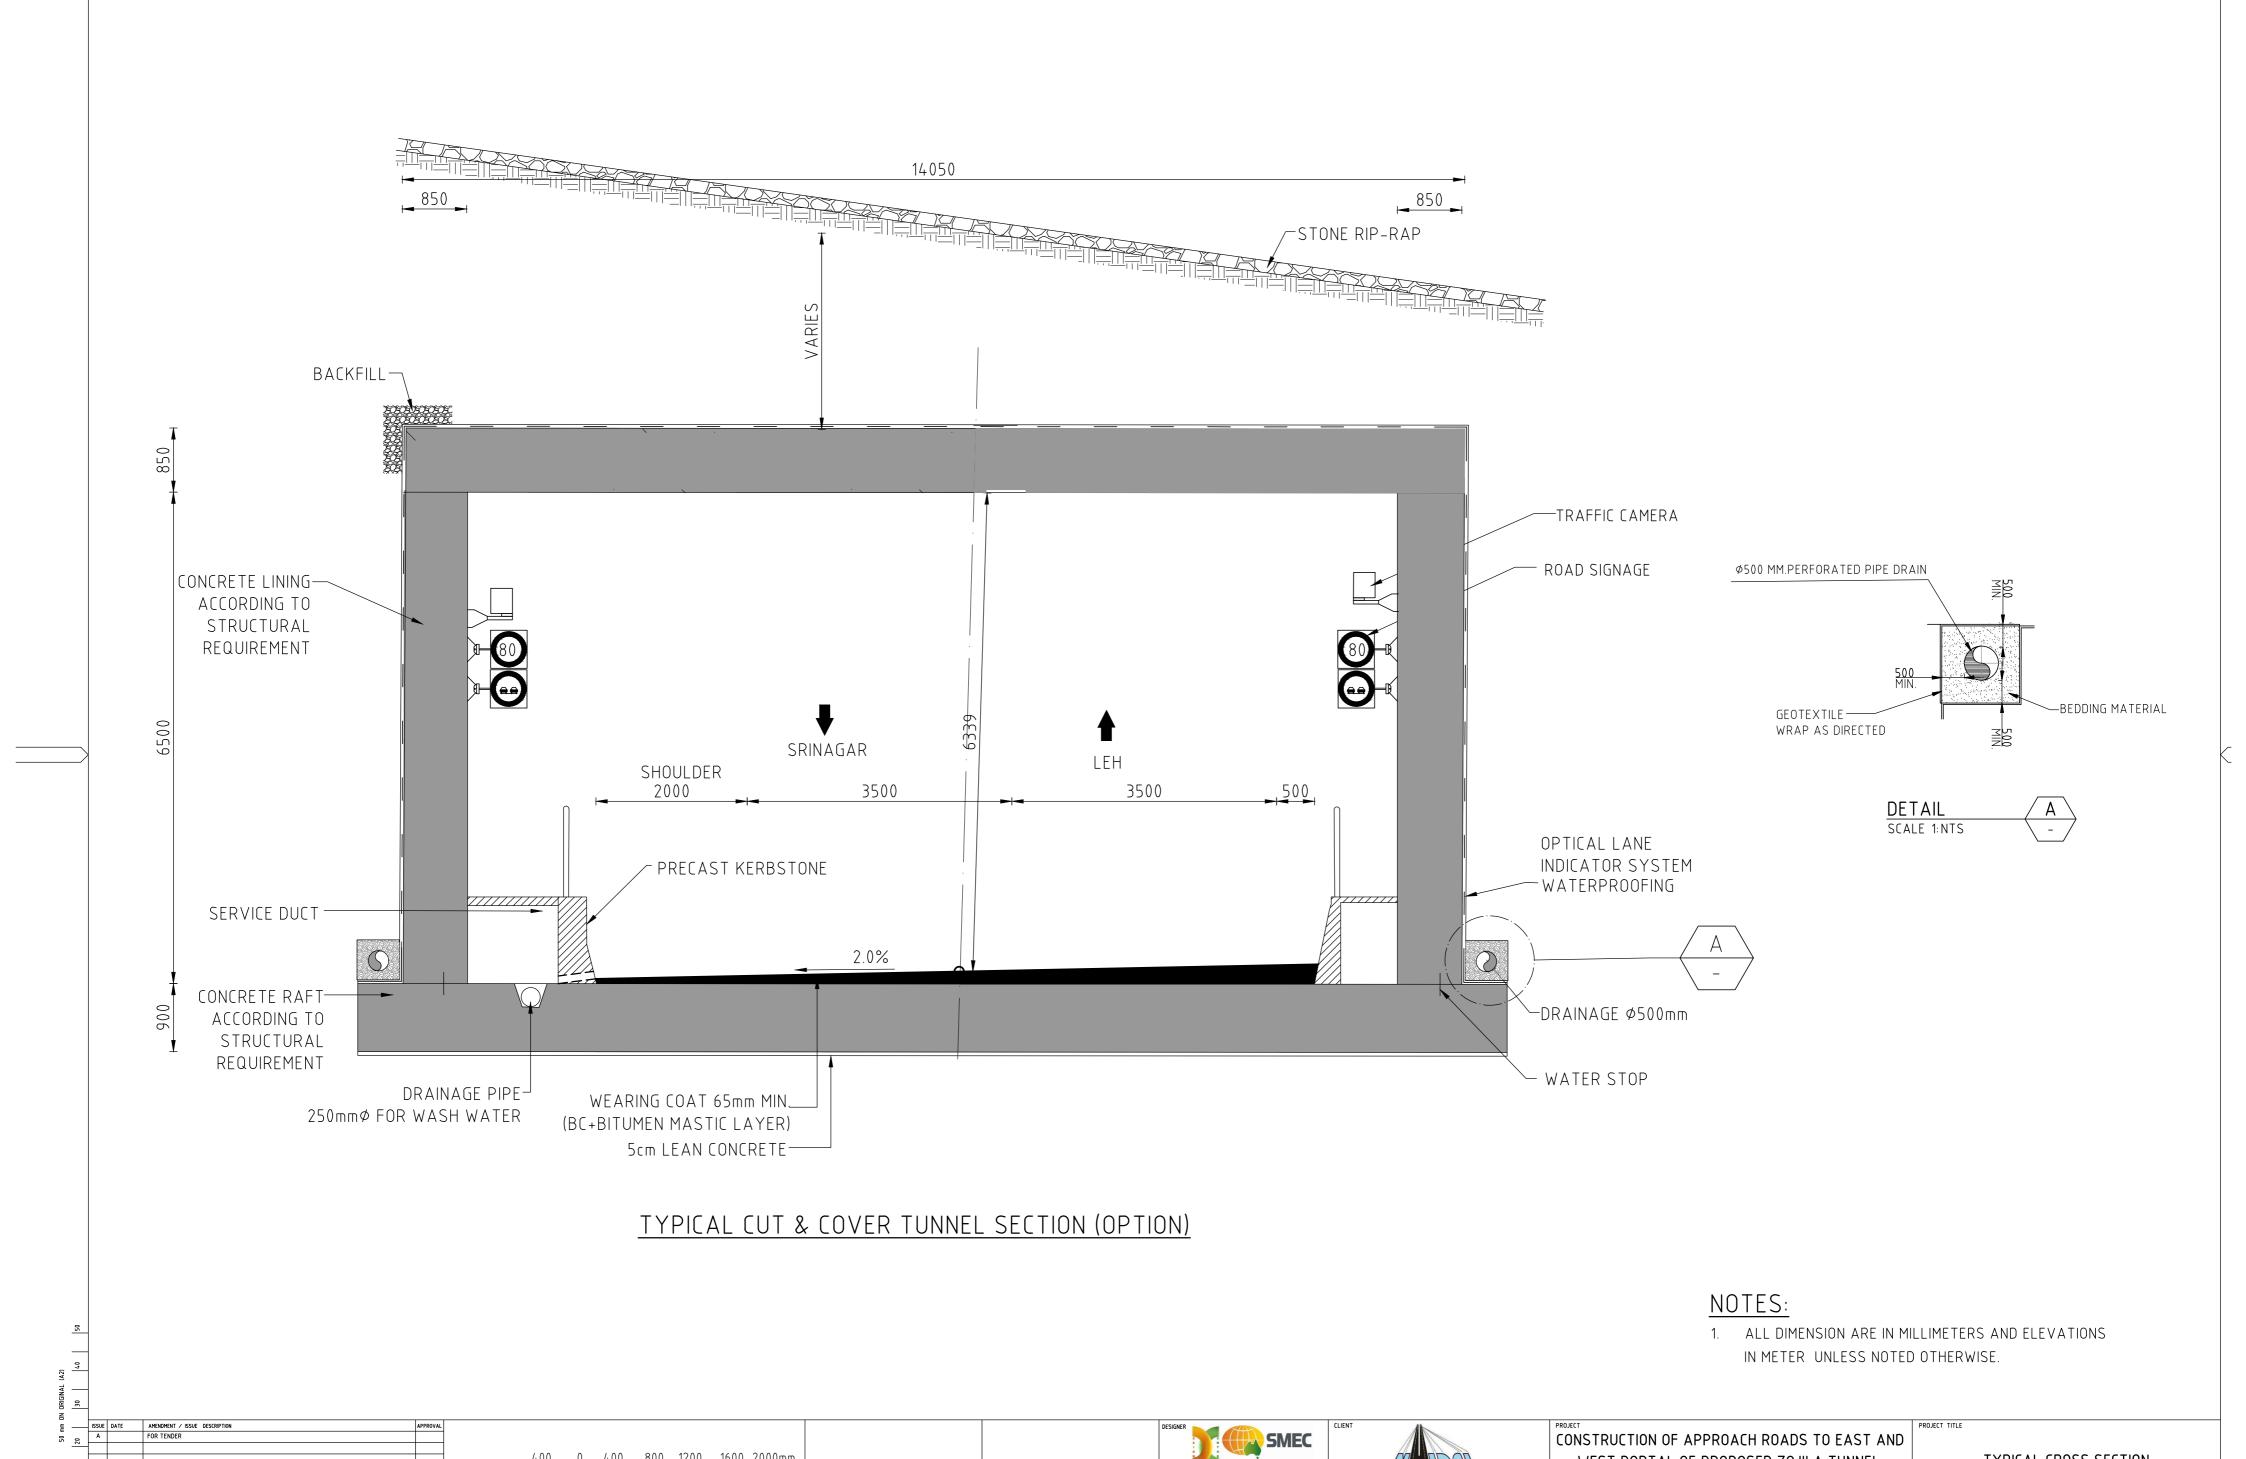

06 Mar 2020 15:09:44

CONSULTANT SIGNATURE

NATIONAL HIGHWAYS & INFRASTRUCTURE DEVELOPMENT CORPORATION LTD. PTI BUILDING . 4 PARLIAMENT STREET , SANSAD MARG AREA, NEW DELHI- 110001

TYPICAL CROSS SECTION

(SHEET 6)

7061520-TCS-002-005A A

WEST PORTAL OF PROPOSED ZOJILA TUNNEL

WITH AVALANCHE PROTECTION WORKS


IN THE UT OF JAMMU & KASHMIR AND LADAKH


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CLEINT APPROVED

SCALE 1: 40


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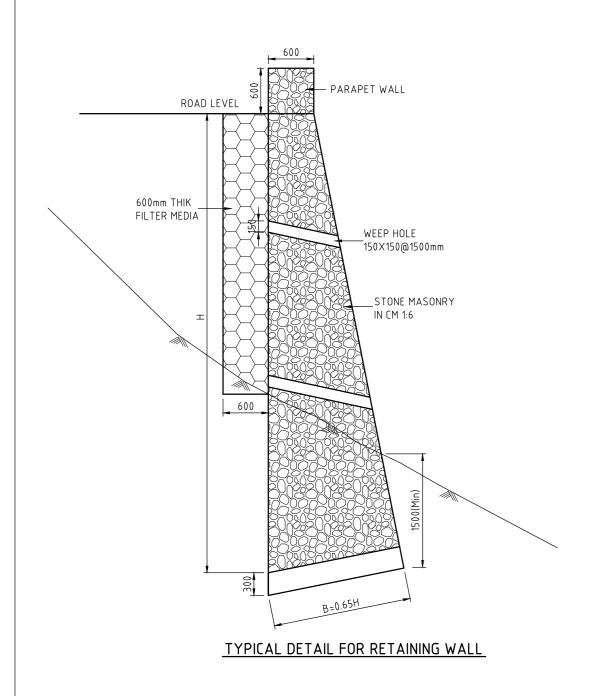


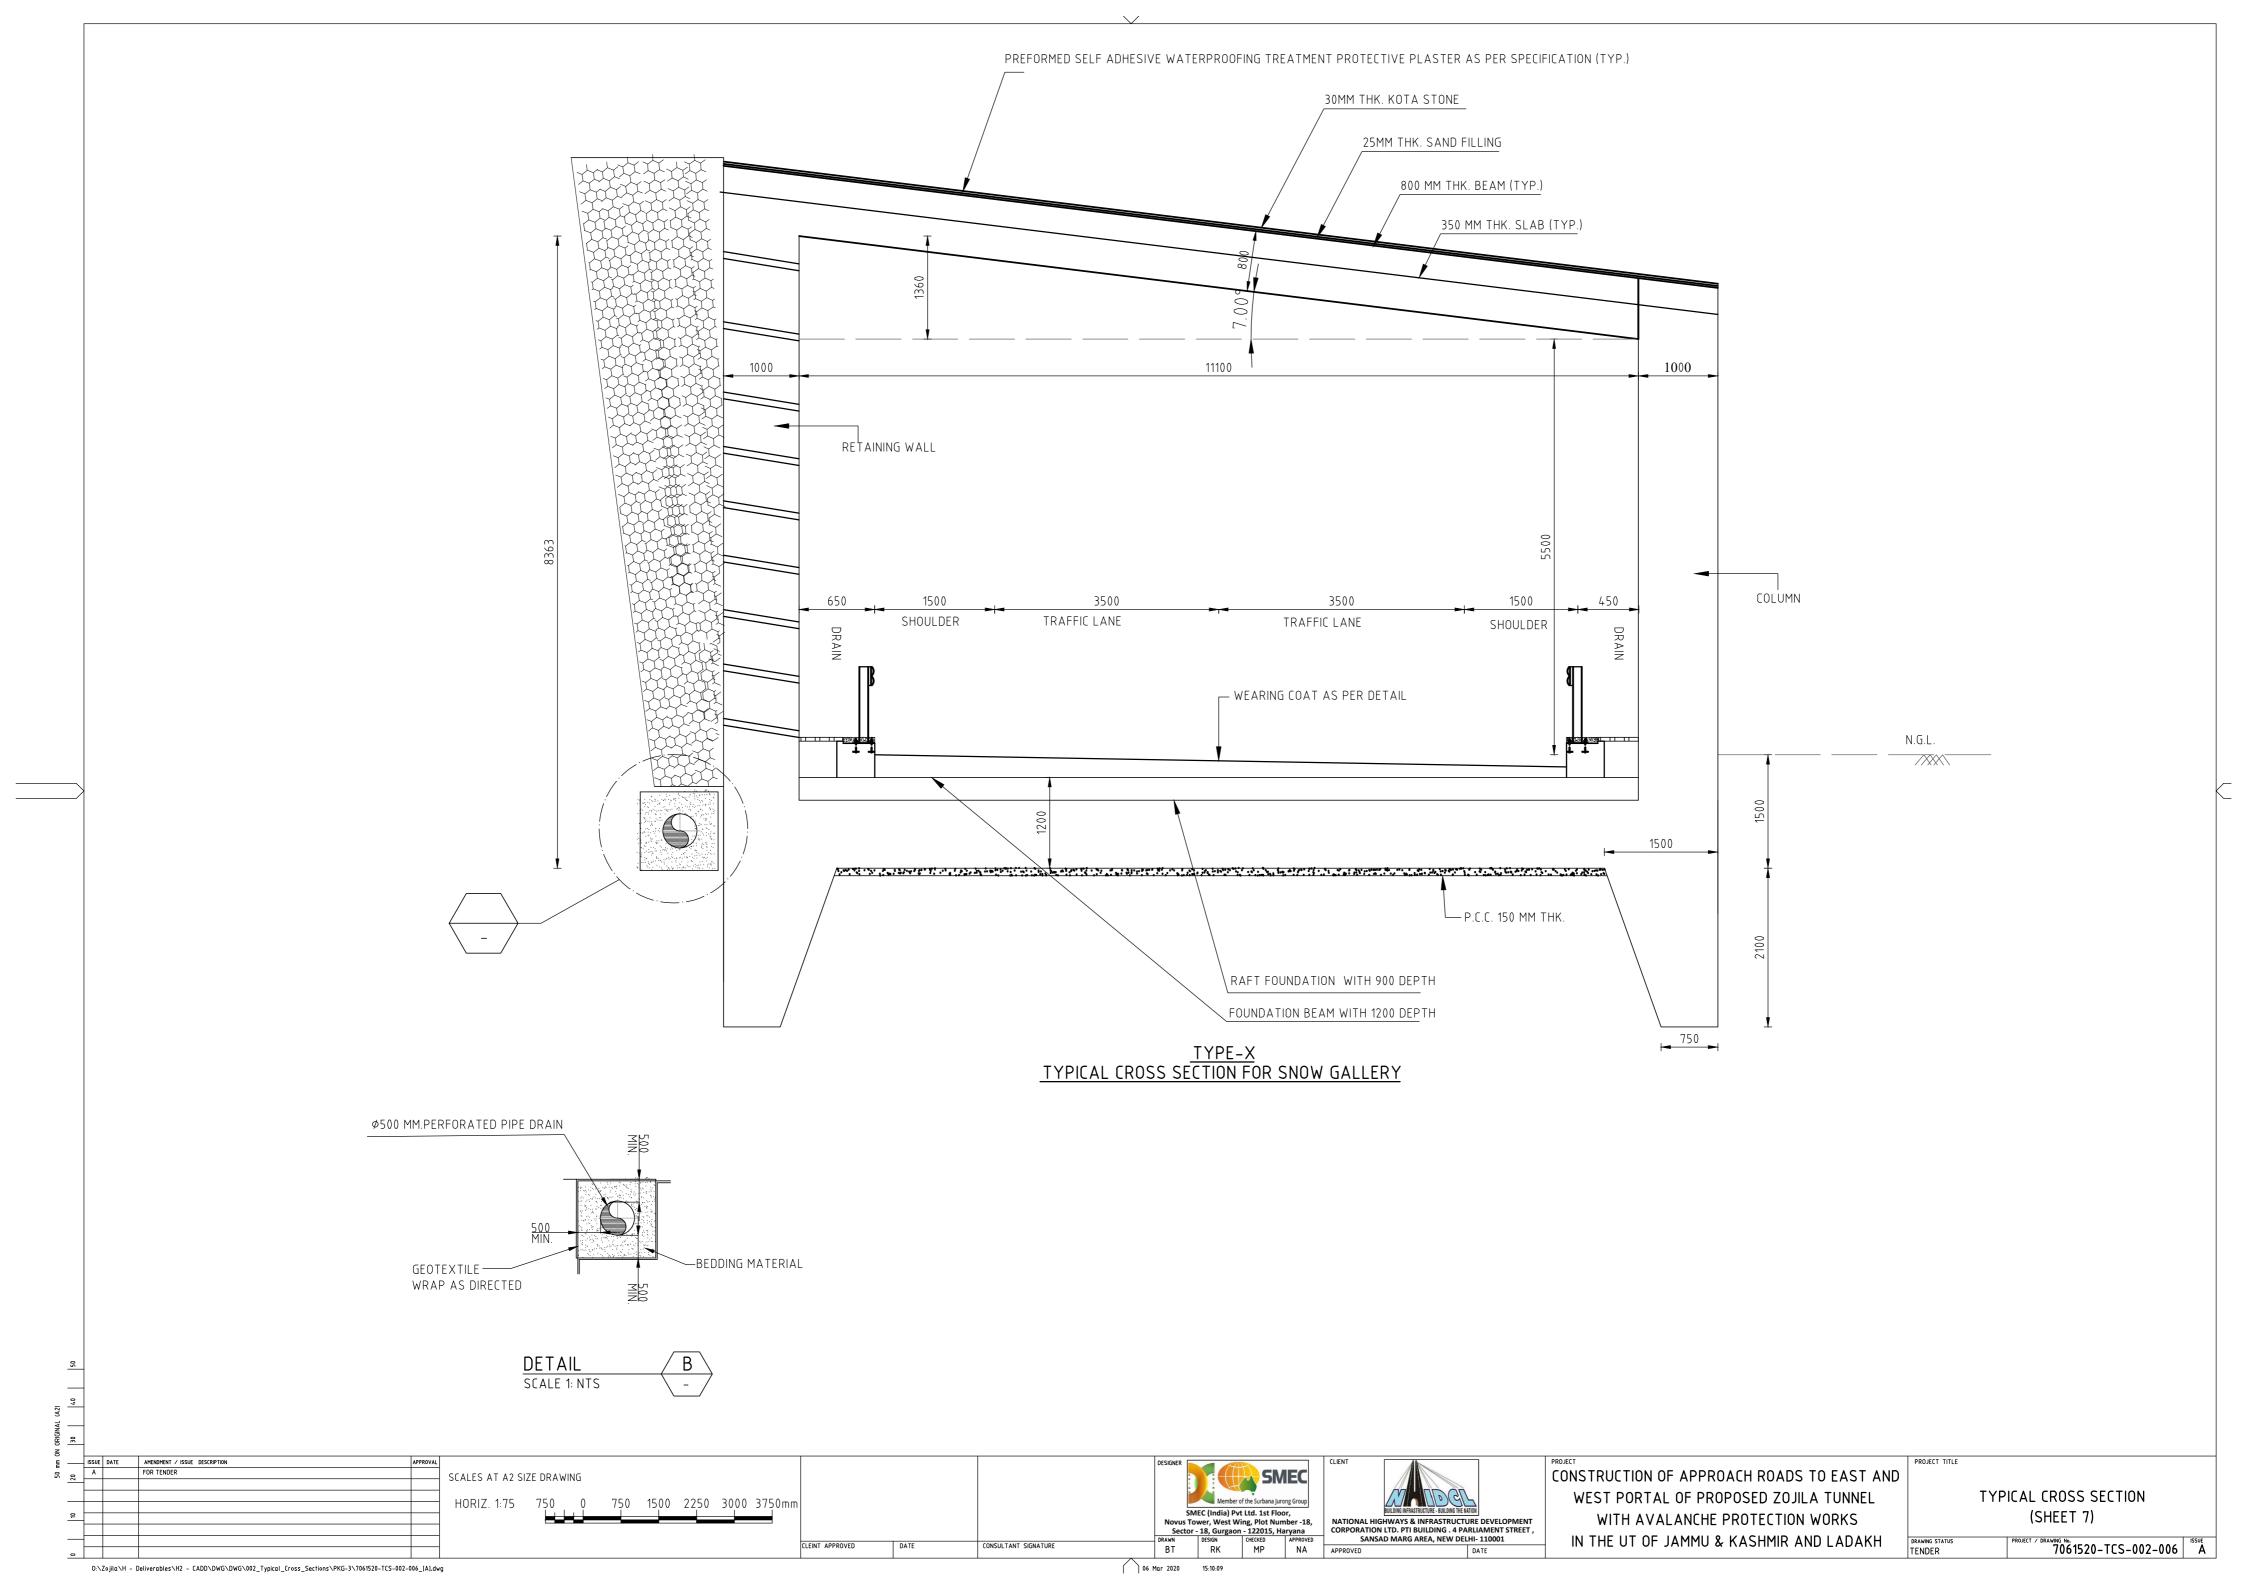



# TCS TYPE XI TYPICAL CROSS-SECTION OF BRIDGE WITH PROTECTED FOOTPATH

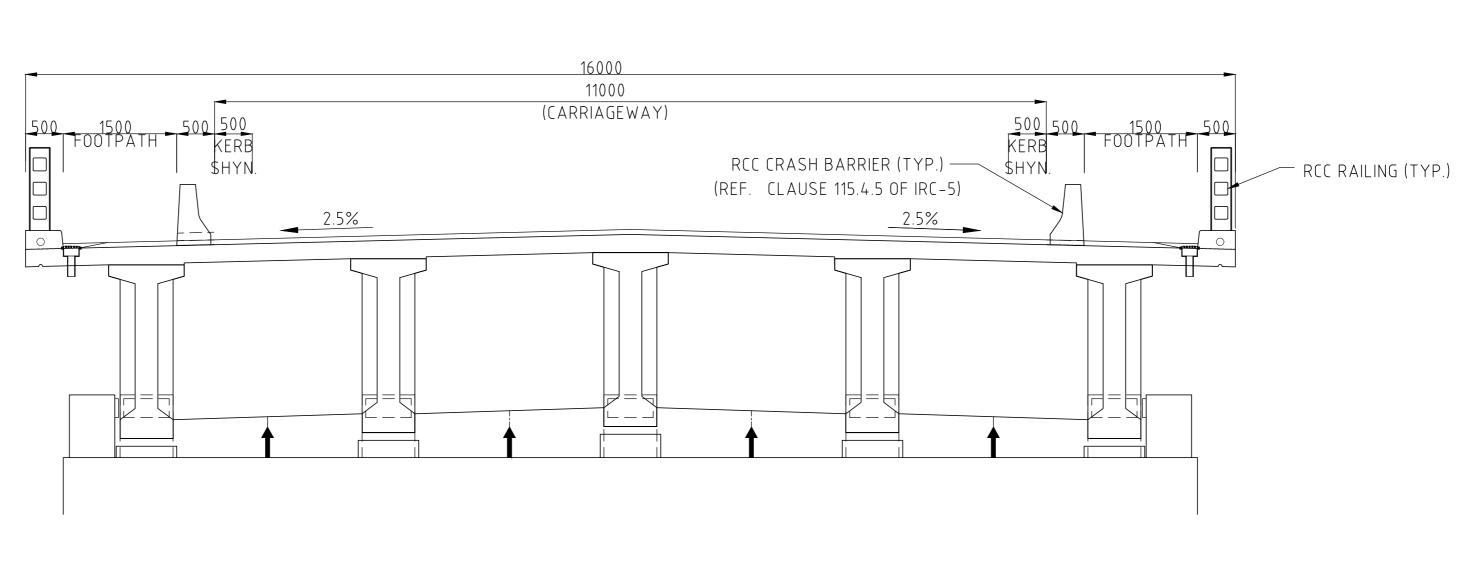
AS PER IRC-SP-73-2015




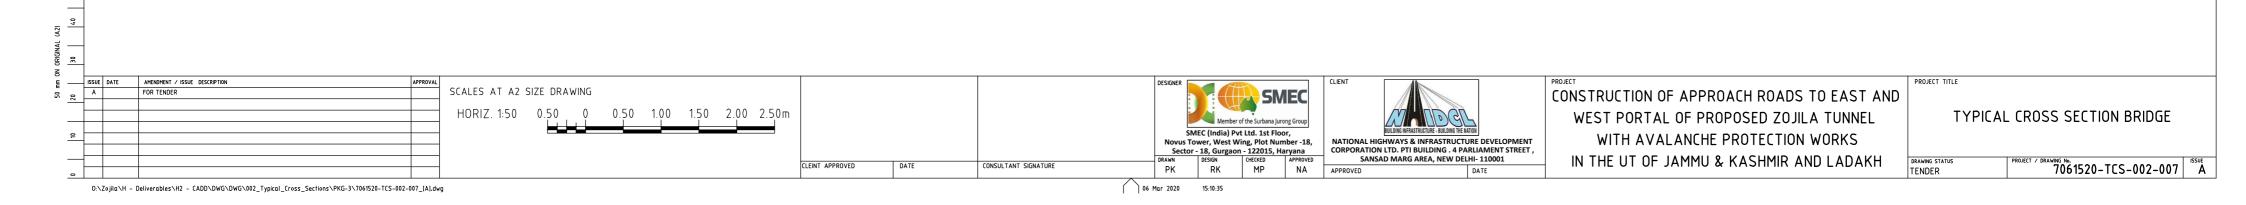

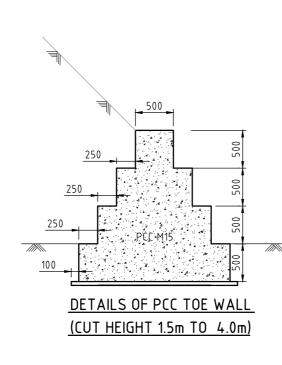

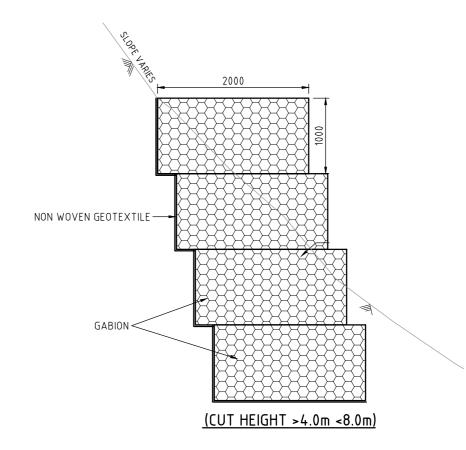

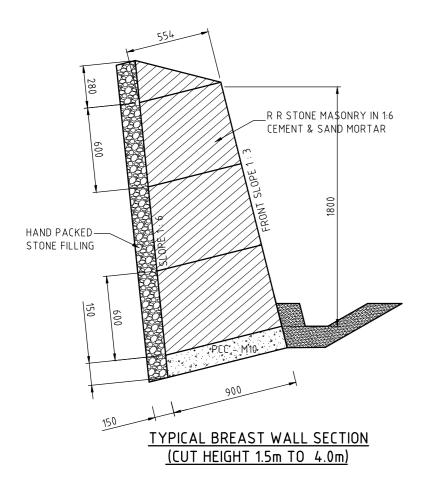

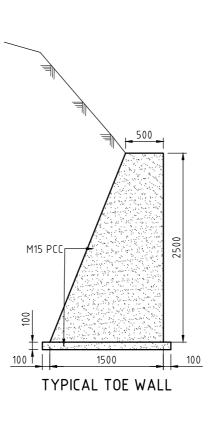

### NOTES:-


- 1). EXTRA WIDENING AS PER IRC-73 & IRC-52 PROPOSED AT CURVE LOCATIONS WITH RADIUS LESS THAN 300m.
- 2). SLOPE TREATMENT SHOWN ON HILL/VALLEY SLOPES ARE INDICATIVE AND MAY VARY BASED ON CONFIRMATORY GEO TECHNICAL INVESTIGATION AND GEOLOGICAL STUDY
- 3). THE TYPE OF PROTECTION MATERIAL FOR RETAINING WALL, BREAST WALL MAY BE CHANGED BASED ON SITE REQUIREMENT.
- 4). FOR DETAILS OF GUARD RAIL / MBCB REFER STANDARD DRAWINGS
- 5). MIN. CBR 15% (LESS CBR SHALL BE TREATED TO BE REPLACED WITH SELECTED EARTH WITH CBR >15%




CONSTRUCTION OF APPROACH ROADS TO EAST AND
WEST PORTAL OF PROPOSED ZOJILA TUNNEL
WITH AVALANCHE PROTECTION WORKS
IN THE UT OF JAMMU & KASHMIR AND LADAKH


TYPICAL WALL DETAIL

ANING STATUS PROJECT / DRAWING No. 7061520-TCS-002-011 A

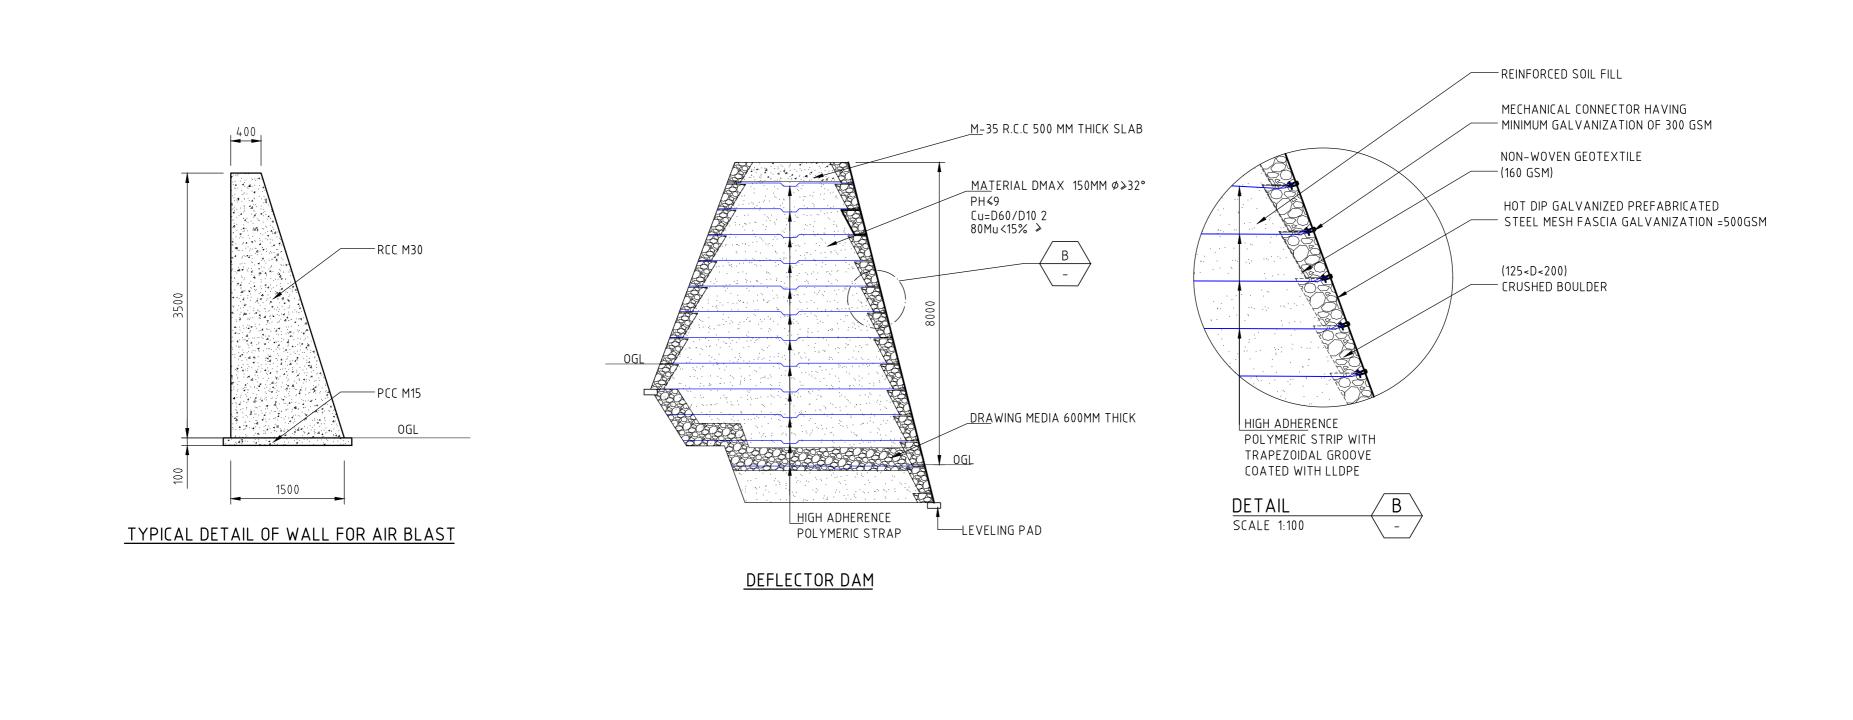

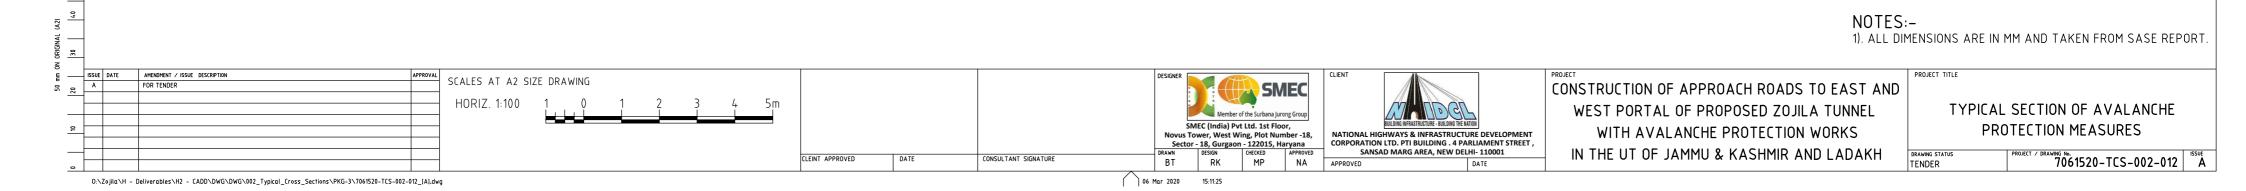

|        | Design (        | Chainage      |            |             |  |  |
|--------|-----------------|---------------|------------|-------------|--|--|
| S. No. | From (km)       | То            | Length (m) | Type of TCS |  |  |
|        | i i olii (kili) | (km)          |            |             |  |  |
|        |                 | Approach Road | -1         |             |  |  |
| 1.00   | 9760.00         | 9796.00       | 36.00      | TCS VIII    |  |  |
| 2.00   | 9796.00         | 10106.00      | 310.00     | TCS IX      |  |  |
| 3.00   | 10106.00        | 10146.00      | 40.00      | TCS VIII    |  |  |
| 4.00   | 10146.00        | 10276.00      | 130.00     | TCS VI      |  |  |
| 5.00   | 10276.00        | 10506.00      | 230.00     | TCS IX      |  |  |
| 6.00   | 10506.00        | 10566.00      | 60.00      | TCS VIII    |  |  |
| 7.00   | 10566.00        | 11066.00      | 500.00     | TCS VI      |  |  |
| 8.00   | 11066.00        | 11256.00      | 190.00     | TCS VIII    |  |  |
| 9.00   | 11256.00        | 11506.00      | 250.00     | TCS IX      |  |  |
| 10.00  | 11506.00        | 11586.00      | 80.00      | TCS VIII    |  |  |
| 11.00  | 11586.00        | 12626.00      | 1040.00    | TCS VI      |  |  |
| 12.00  | 12626.00        | 12806.00      | 180.00     | TCS III     |  |  |
| 13.00  | 12806.00        | 13006.00      | 200.00     | TCS VIII    |  |  |
| 14.00  | 13006.00        | 13406.00      | 400.00     | TCS IX      |  |  |
| 15.00  | 13406.00        | 13486.00      | 80.00      | TCS VIII    |  |  |
| 16.00  | 13486.00        | 13876.00      | 390.00     | TCS VI      |  |  |
| 17.00  | 13876.00        | 13926.00      | 50.00      | TCS V       |  |  |
| 18.00  | 13926.00        | 14006.00      | 80.00      | TCS VIII    |  |  |
| 19.00  | 14006.00        | 14356.00      | 350.00     | TCS IX      |  |  |
| 20.00  | 14356.00        | 14446.00      | 90.00      | TCS VIII    |  |  |
| 21.00  | 14446.00        | 14586.00      | 140.00     | TCS V       |  |  |
| 22.00  | 14586.00        | 14656.00      | 70.00      | TCS VIII    |  |  |
| 23.00  | 14656.00        | 14856.00      | 200.00     | TCS IX      |  |  |
| 24.00  | 14856.00        | 14946.00      | 90.00      | TCS VIII    |  |  |
| 25.00  | 14946.00        | 15036.00      | 90.00      | TCS III     |  |  |
| 26.00  | 15036.00        | 15156.00      | 120.00     | TCS VI      |  |  |
| 27.00  | 15156.00        | 15206.00      | 50.00      | TCS V       |  |  |
| 28.00  | 15206.00        | 15306.00      | 100.00     | TCS VIII    |  |  |
| 29.00  | 15306.00        | 15766.00      | 460.00     | TCS IX      |  |  |
| 30.00  | 15766.00        | 15906.00      | 140.00     | TCS VIII    |  |  |
| 31.00  | 15906.00        | 16226.00      | 320.00     | TCS III     |  |  |
| 32.00  | 16226.00        | 16356.00      | 130.00     | TCS V       |  |  |
| 33.00  | 16356.00        | 16656.00      | 300.00     | TCS X       |  |  |
| 34.00  | 16656.00        | 16806.00      | 150.00     | TCS IX      |  |  |
| 35.00  | 16806.00        | 16956.00      | 150.00     | TCS X       |  |  |
| 36.00  | 16956.00        | 17172.50      | 216.50     | TCS VI      |  |  |
| 37.00  | 17172.50        | 17307.50      | 135.00     | TCS XI      |  |  |
| 38.00  | 17307.50        | 17814.00      | 507.50     | TCS VI      |  |  |
|        |                 | Approach Road |            | 1           |  |  |
| 1.00   | 0.00            | 660.00        | 600.00     | TCS VI      |  |  |
|        |                 | otal          | 8714.00    | 1           |  |  |

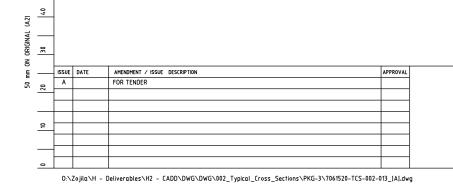


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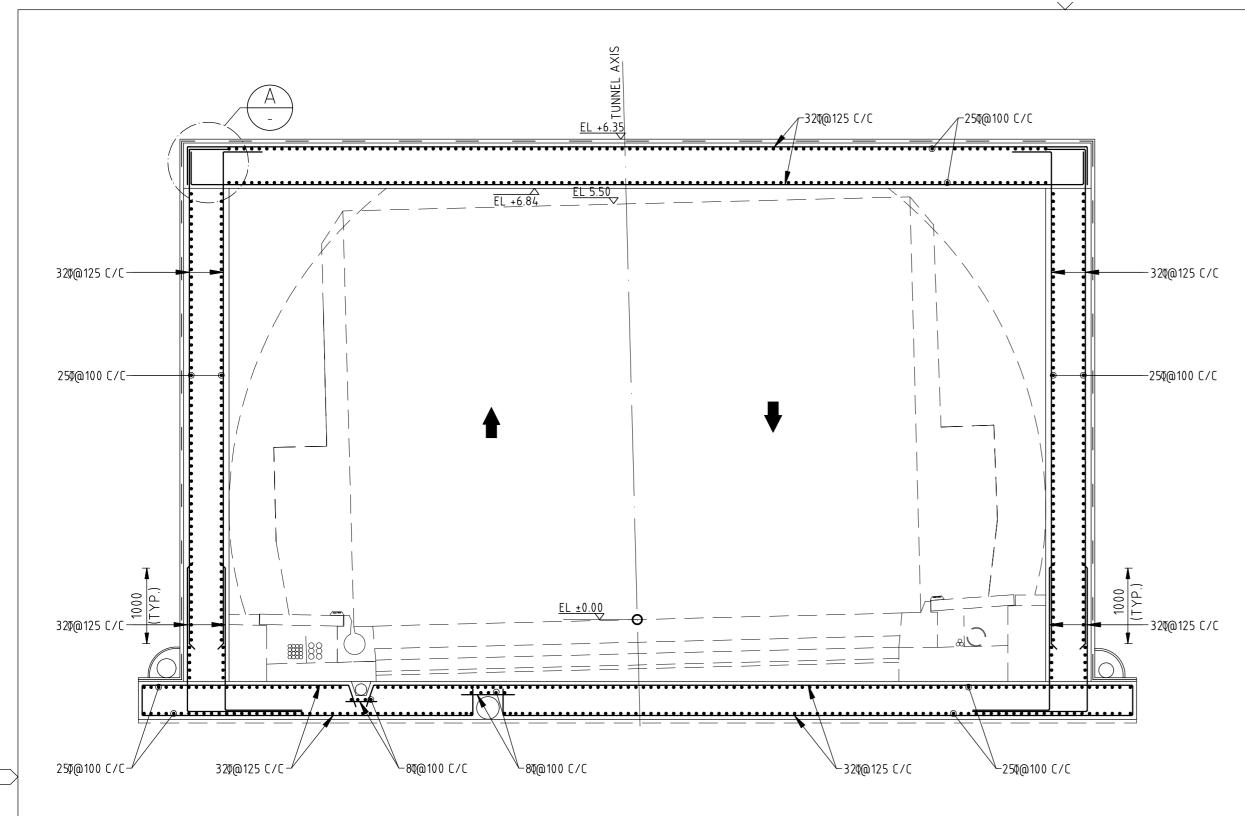


CONSTRUCTION OF APPROACH ROADS TO EAST AND WEST PORTAL OF PROPOSED ZOJILA TUNNEL WITH AVALANCHE PROTECTION WORKS IN THE UT OF JAMMU & KASHMIR AND LADAKH

TYPICAL CROSS SECTION SCHEDULE

PROJECT / DRAWING No. 7061520-TCS-002-013 A




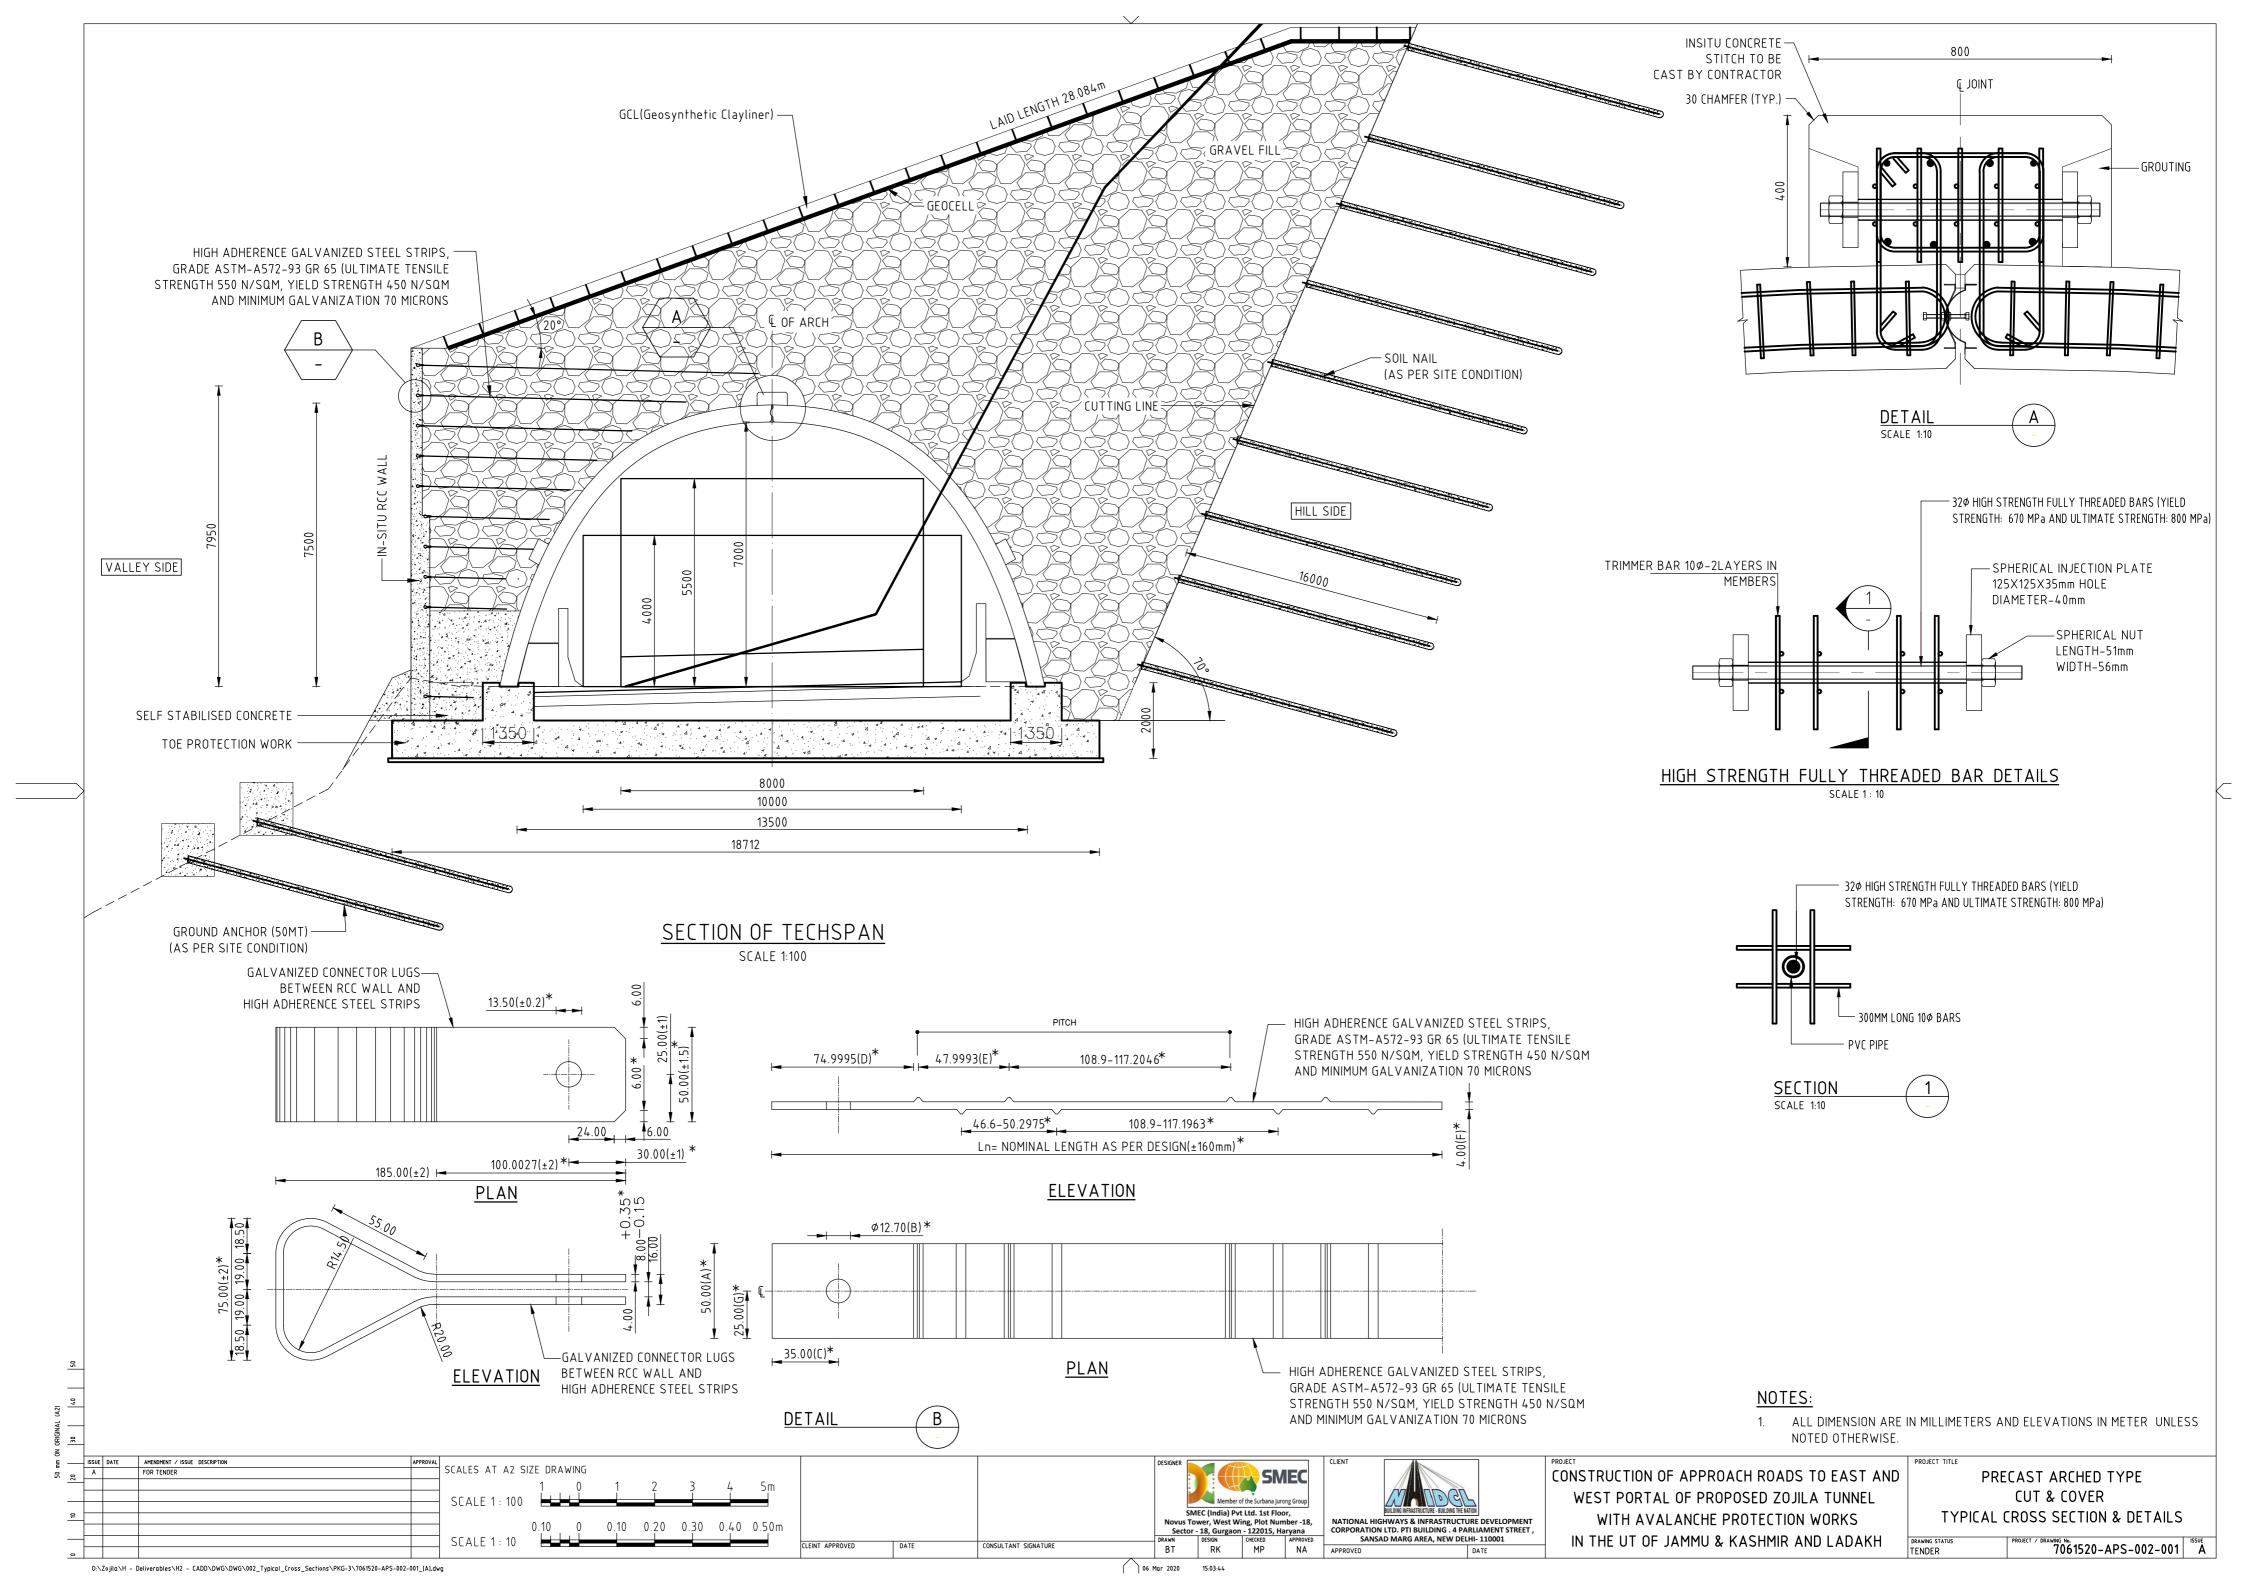

FINAL LINING REINFORCEMENT


TYPICAL CUT & COVER TUNNEL SECTION


SCALE 1: 50

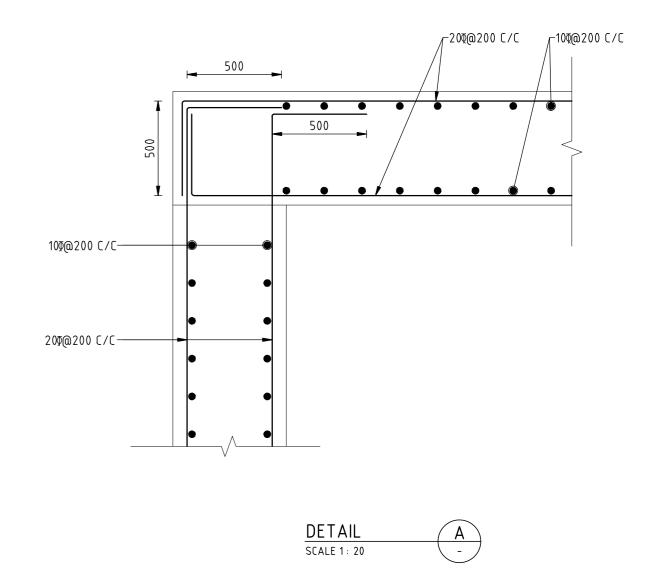

## NOTES:

- CONCRETE LINING IS UNREINFORCED IN GENERAL. SHOWN
  REINFORCEMENT APPLIES TO FIRST 50m OF LINING FROM SOUTH &
  NORTH PORTAL.
- 2. FOR SETOUT DETAILS REFER DRG NO. 7061520-TCS-002-005A.
- 3. ALL LONGITUDINAL AND TRANSVERSE CONSTRUCTION JOINTS SHALL HAVE HYDROPHILIC WATER STOPS.
- 4. SURFACE OF CONSTRUCTION JOINTS SHALL BE CLEARED OF DEBRIS PRIOR TO PLACEMENT OF ADDITIONAL LINING CONCRETE.
- 5. FOR GROUND WATER DRAINAGE ARRANGEMENT DETAILS REFER DRAINAGE DRAWINGS.
- 6. ALL BACKFILL AND CAVITY GROUTING TO BE CARRIED OUT IN ACCORDANCE WITH SPECIFICATION.
- 7. MINIMUM COVER TO REINFORCEMENT SHALL BE AS FOLLOWS:
  (i) EXTERNAL FACE 50mm
  (ii) INTERNAL FACE 50mm
- 8. LAPS SHOWN ON DRAWING ARE INDICATIVE ONLY. ACTUAL BAR BENDING SCHEDULE SHALL BE DEVELOPED BY THE CONTRACTOR AND APPROVED BY THE ENGINEER.
- 9. TYPICAL CHAIR DETAILS TO BE ADJUSTED IN FIELD AS REQUIRED.

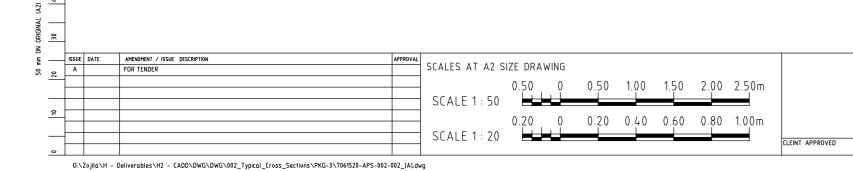

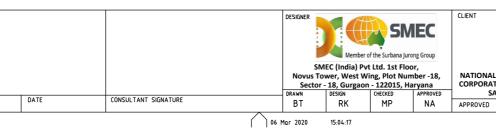




CONSTRUCTION OF APPROACH ROADS TO EAST AND
WEST PORTAL OF PROPOSED ZOJILA TUNNEL
WITH AVALANCHE PROTECTION WORKS
IN THE UT OF JAMMU & KASHMIR AND LADAKH


FINAL LINING REINFORCEMENT


CUT & COVER (OPTION)


TYPICAL CROSS SECTION & DETAILS


DRAWING STATUS
TENDER
PROJECT / DRAWING No.
7061520-APS-002-002
A

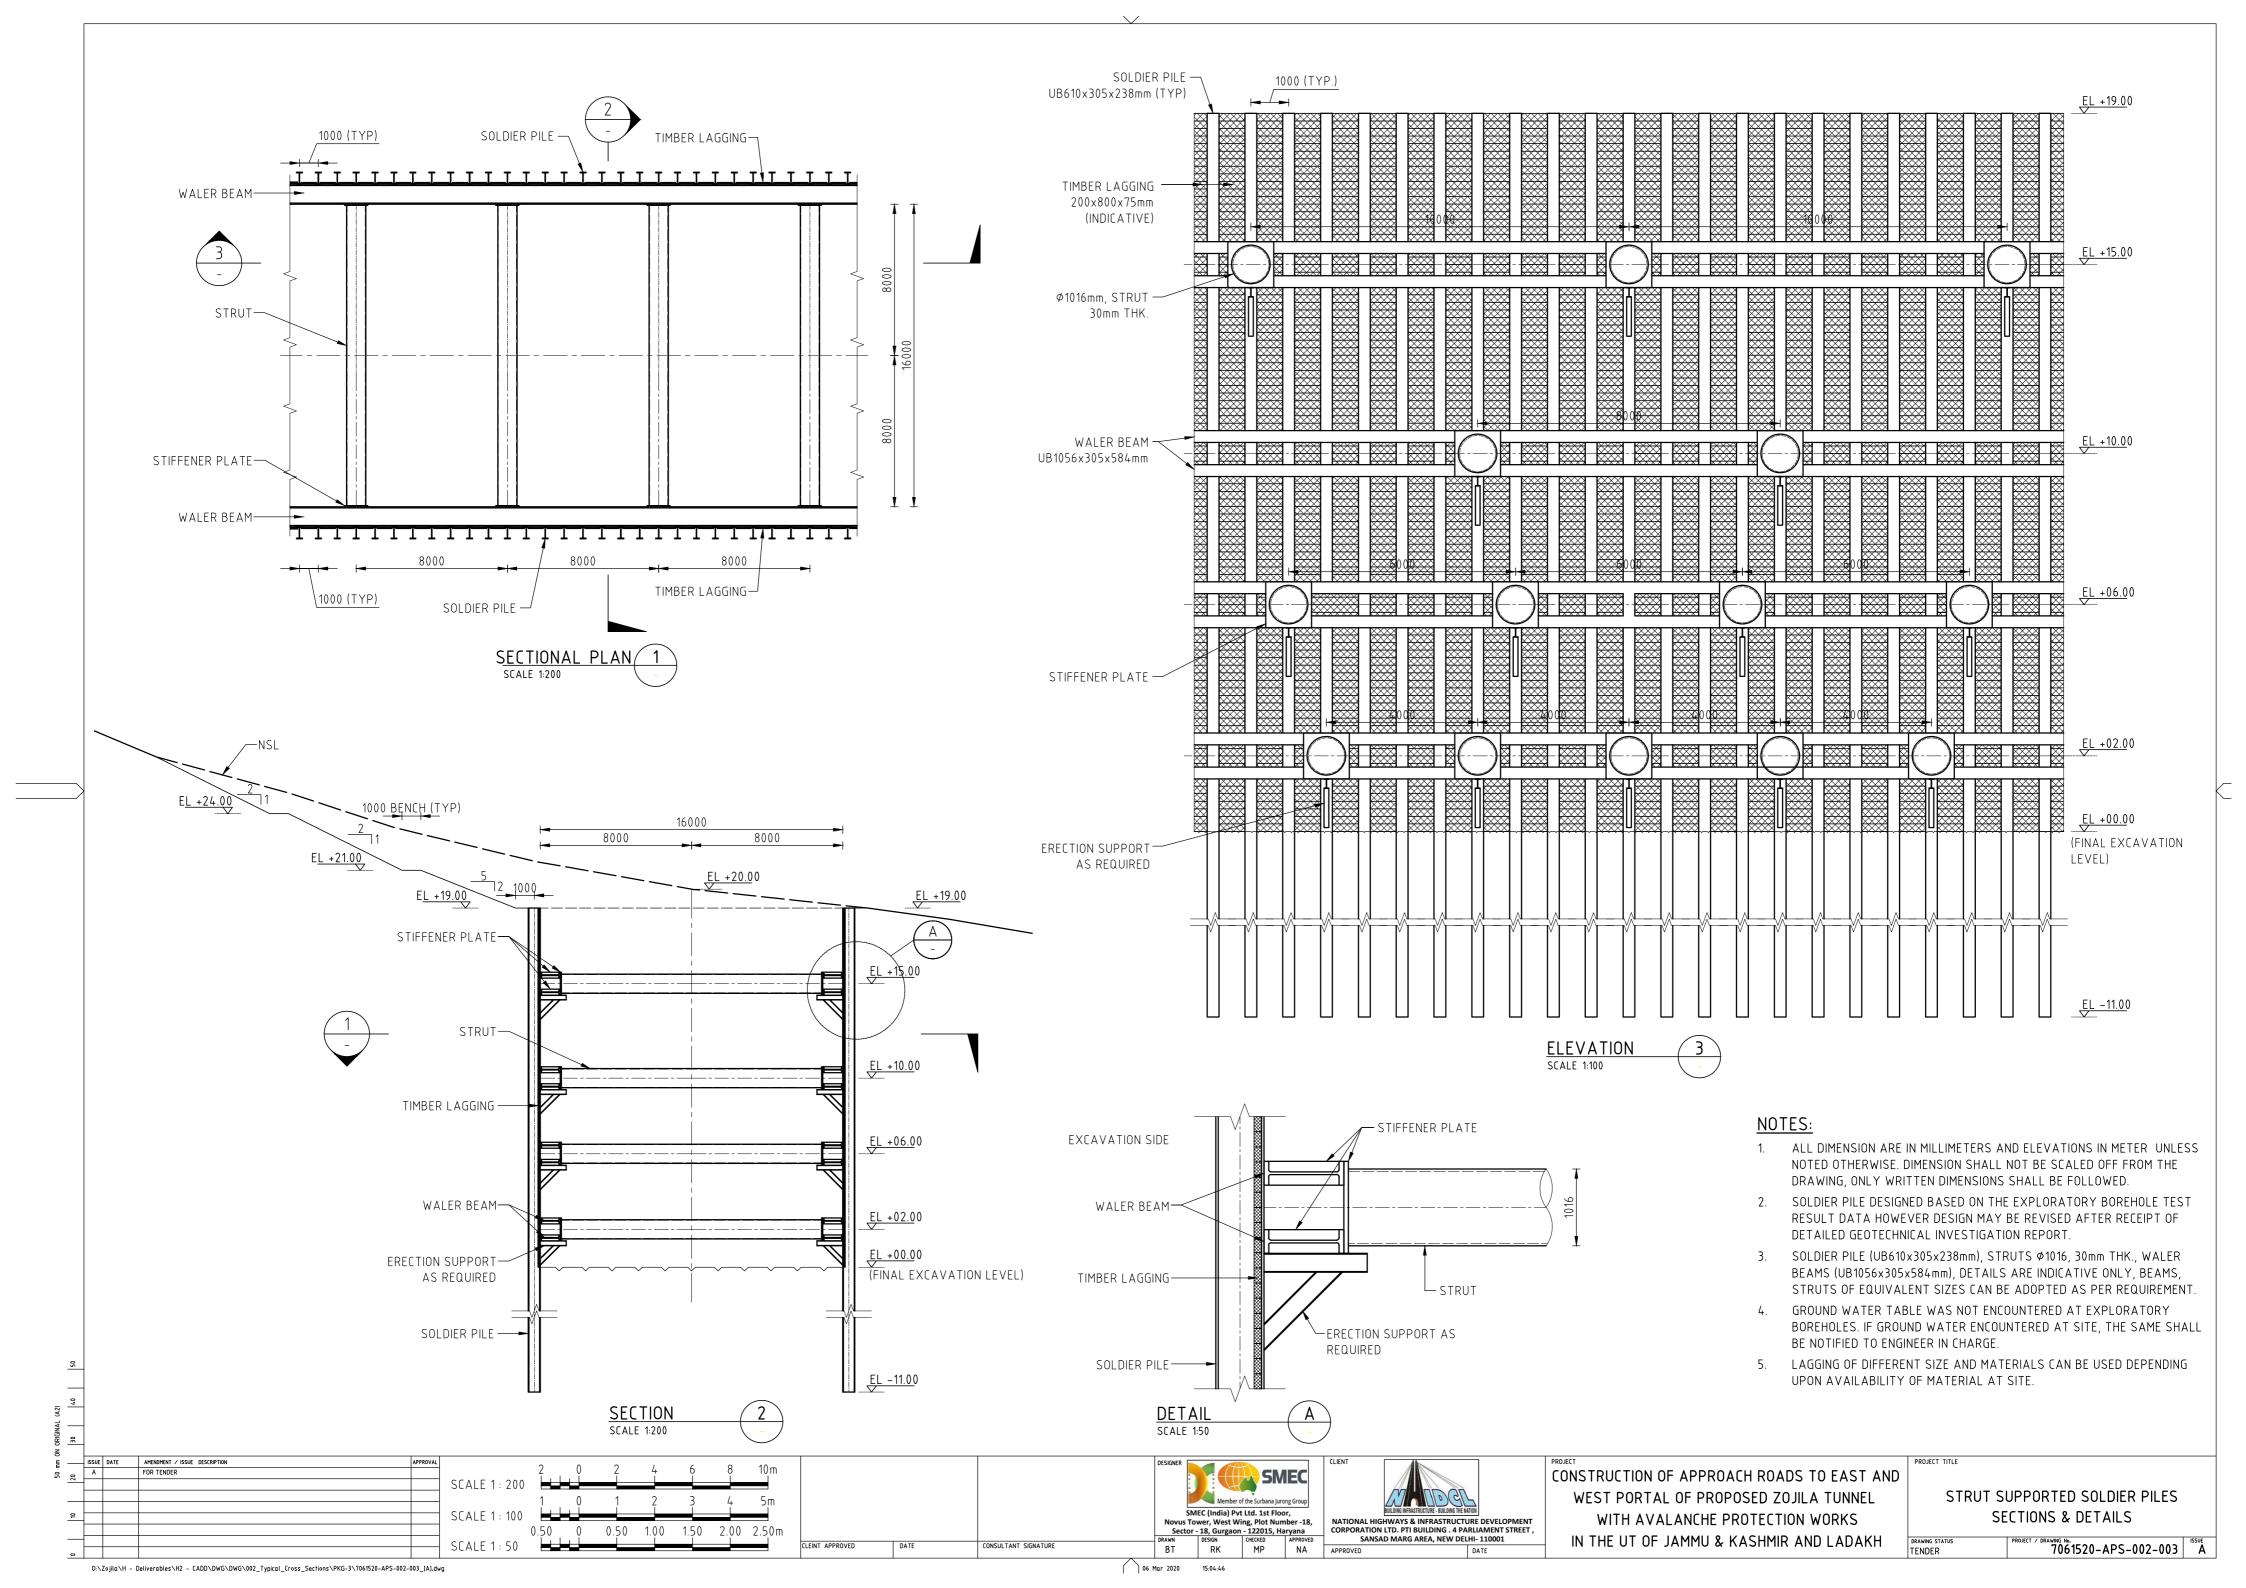


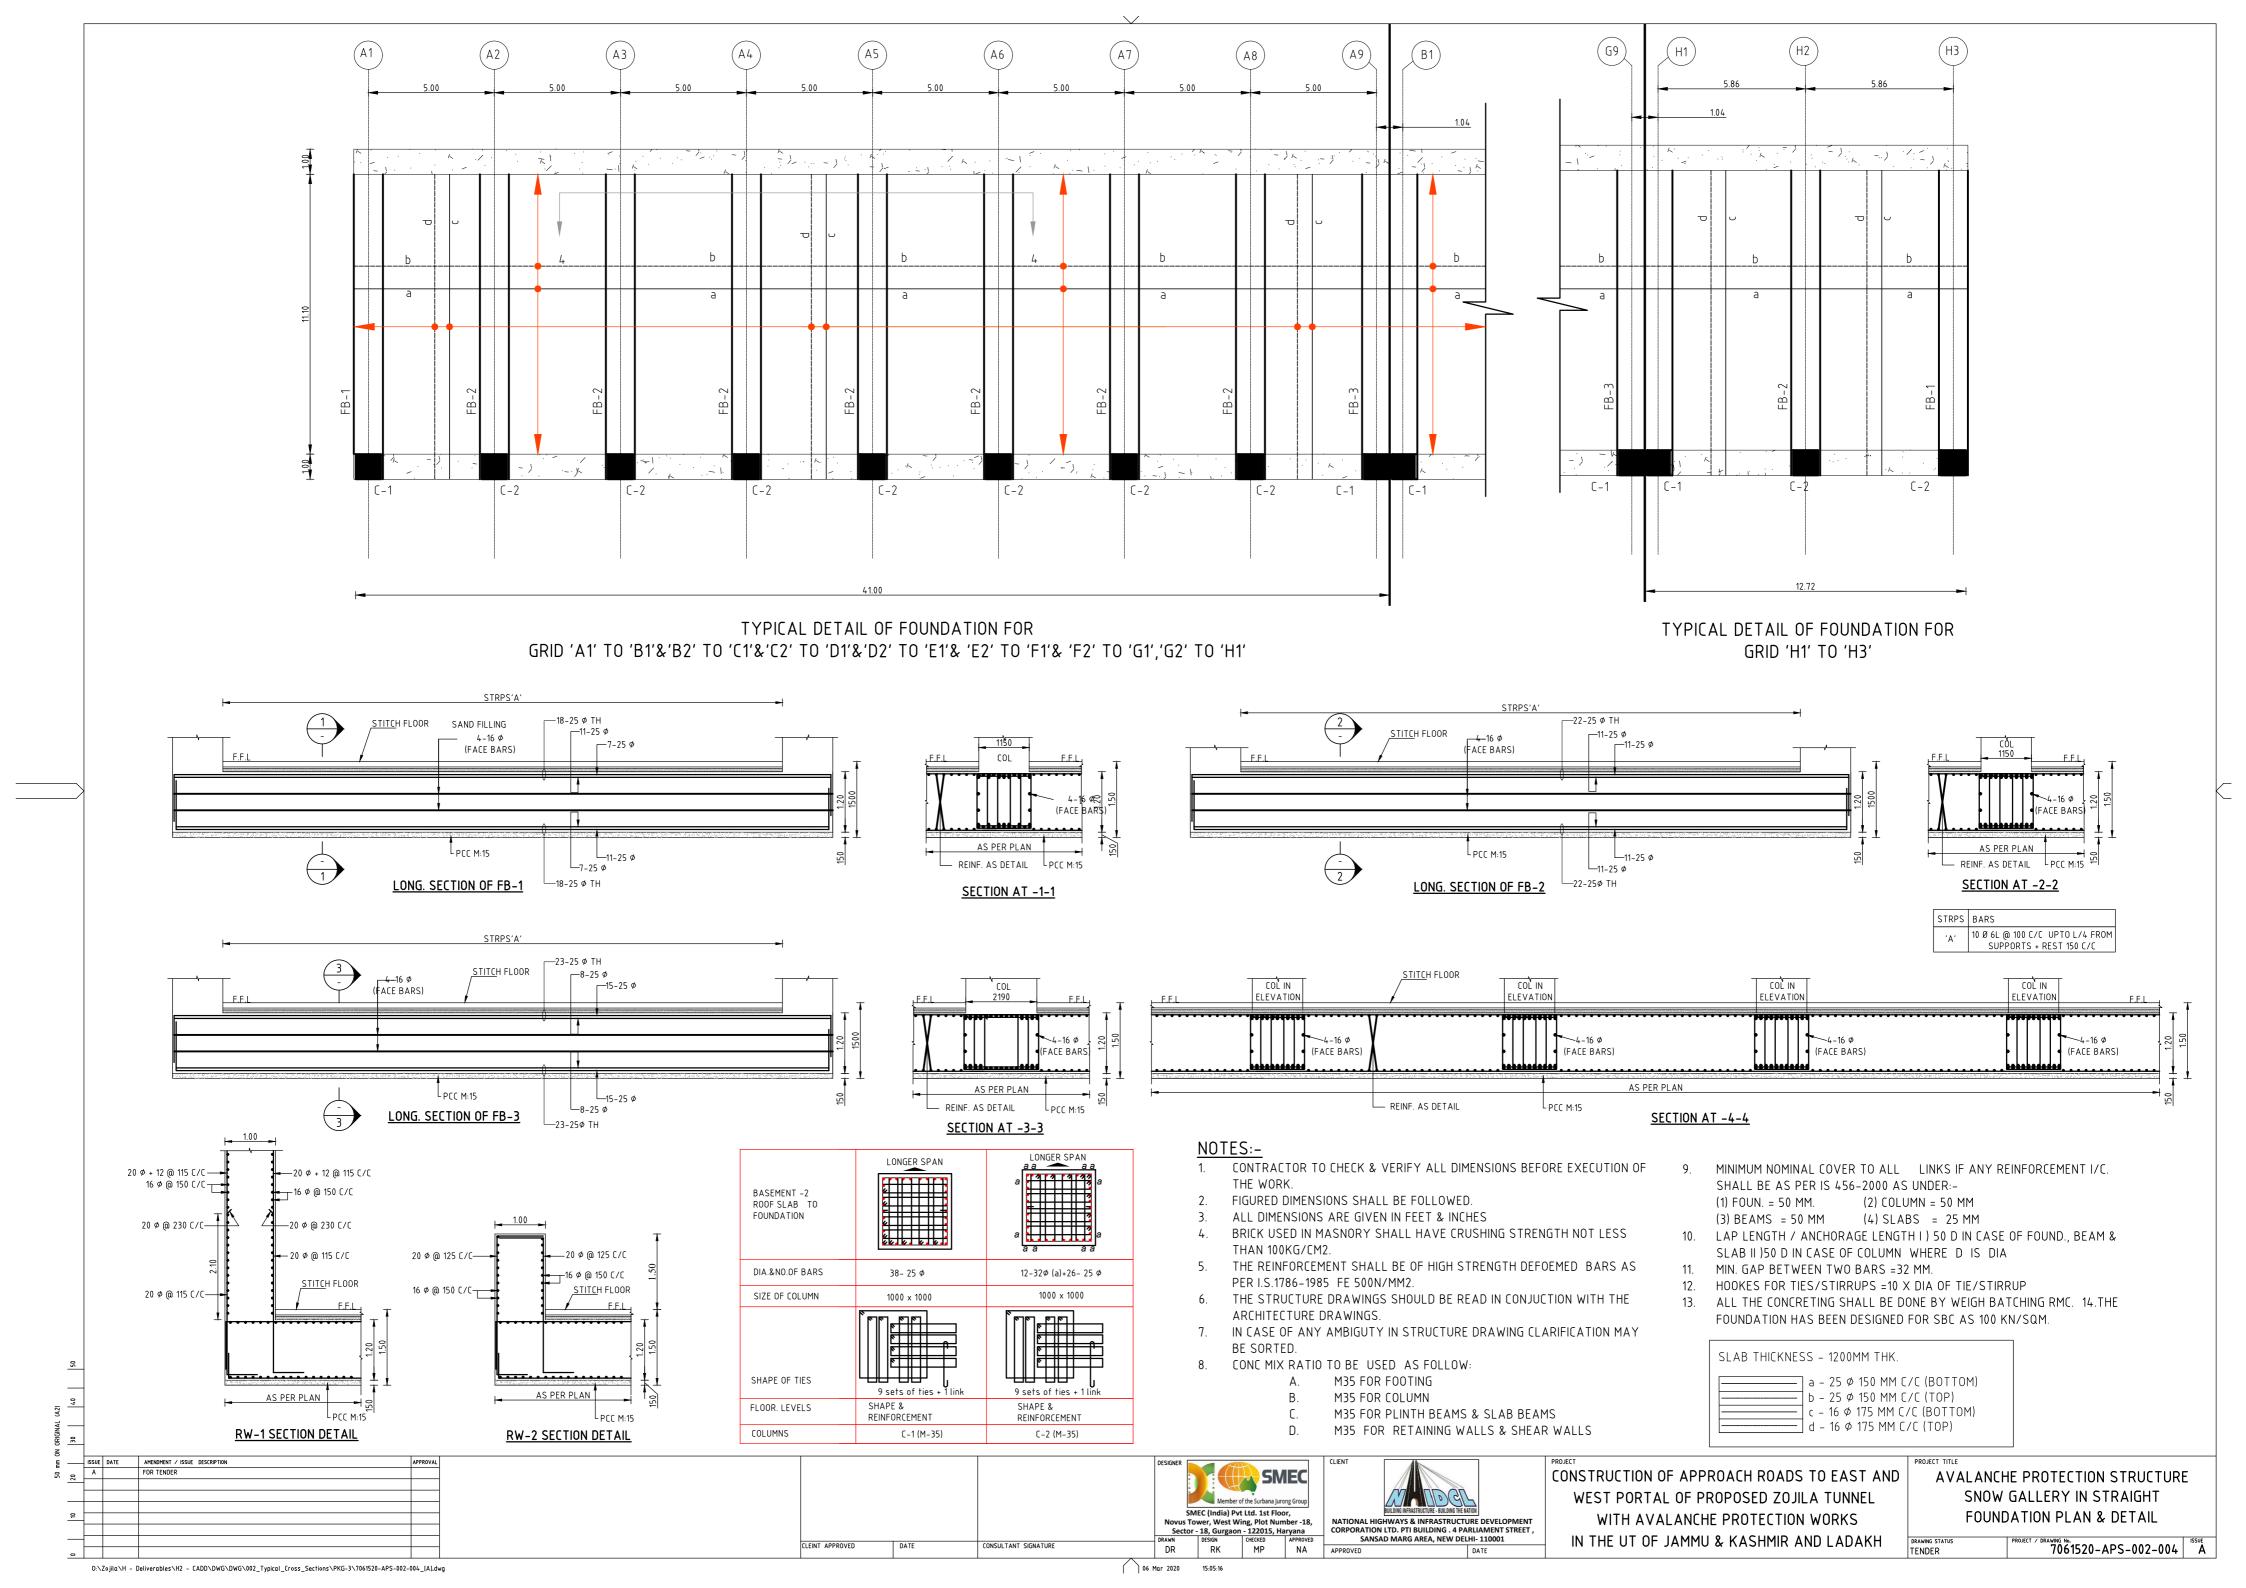


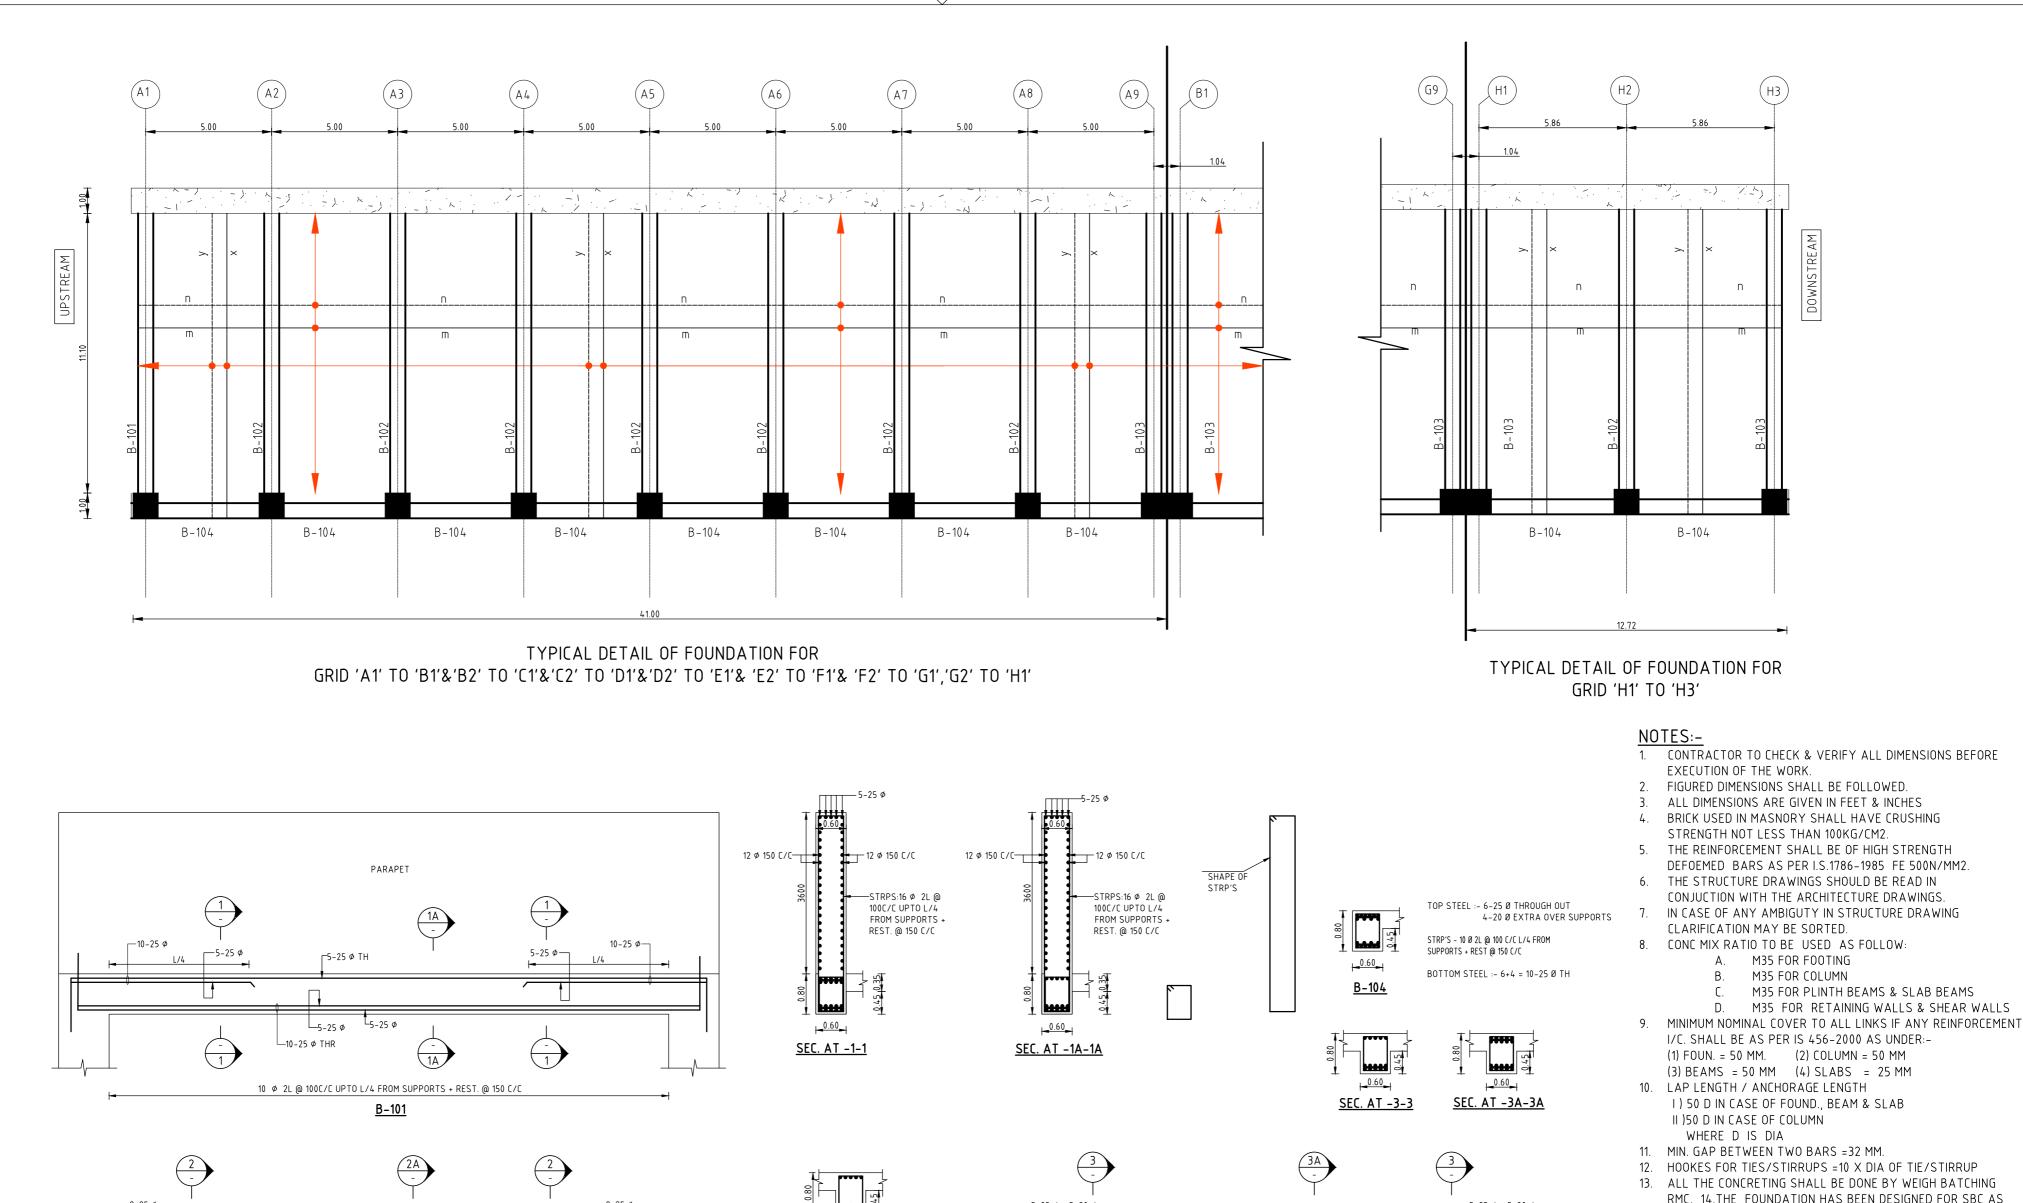


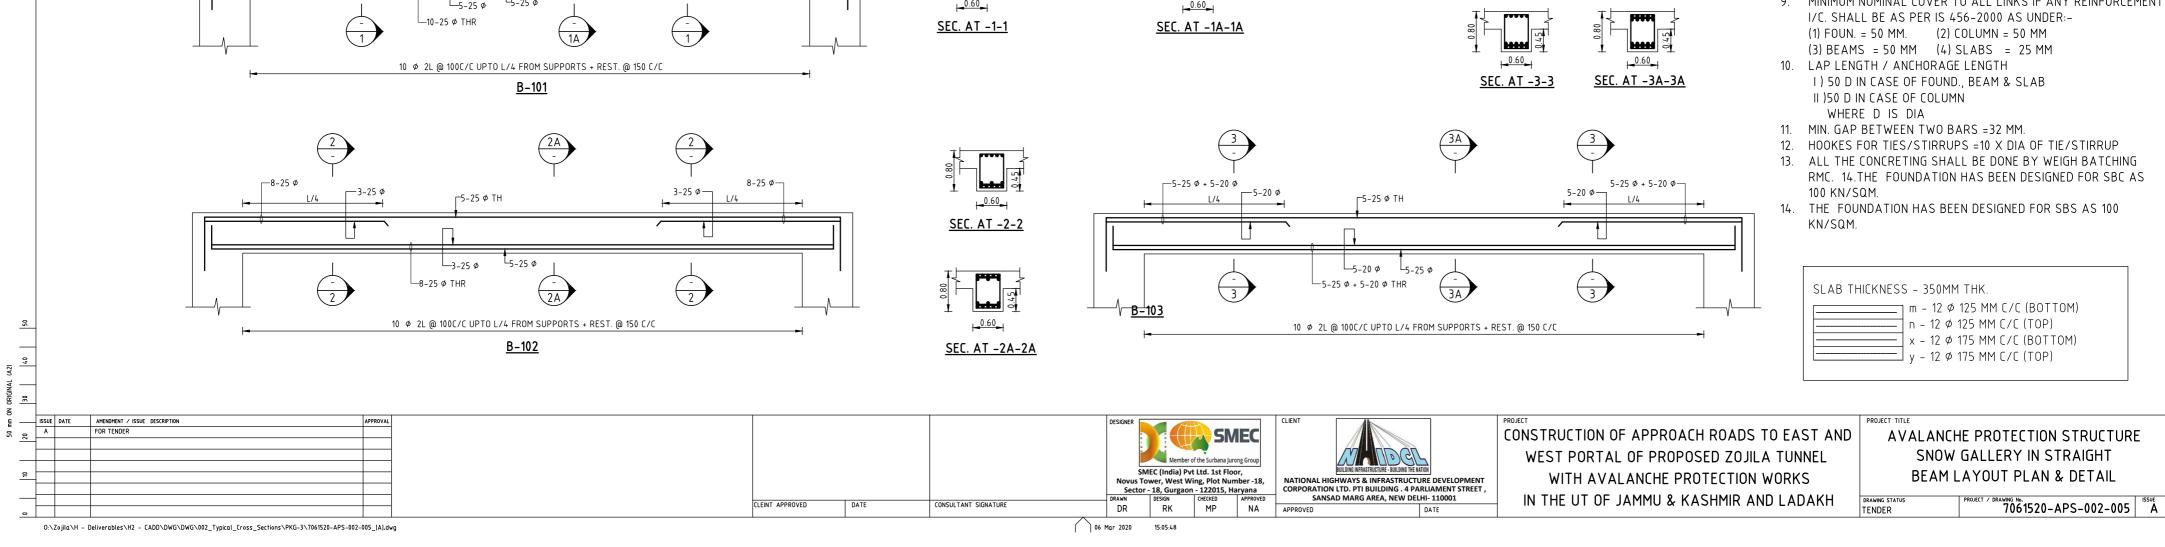


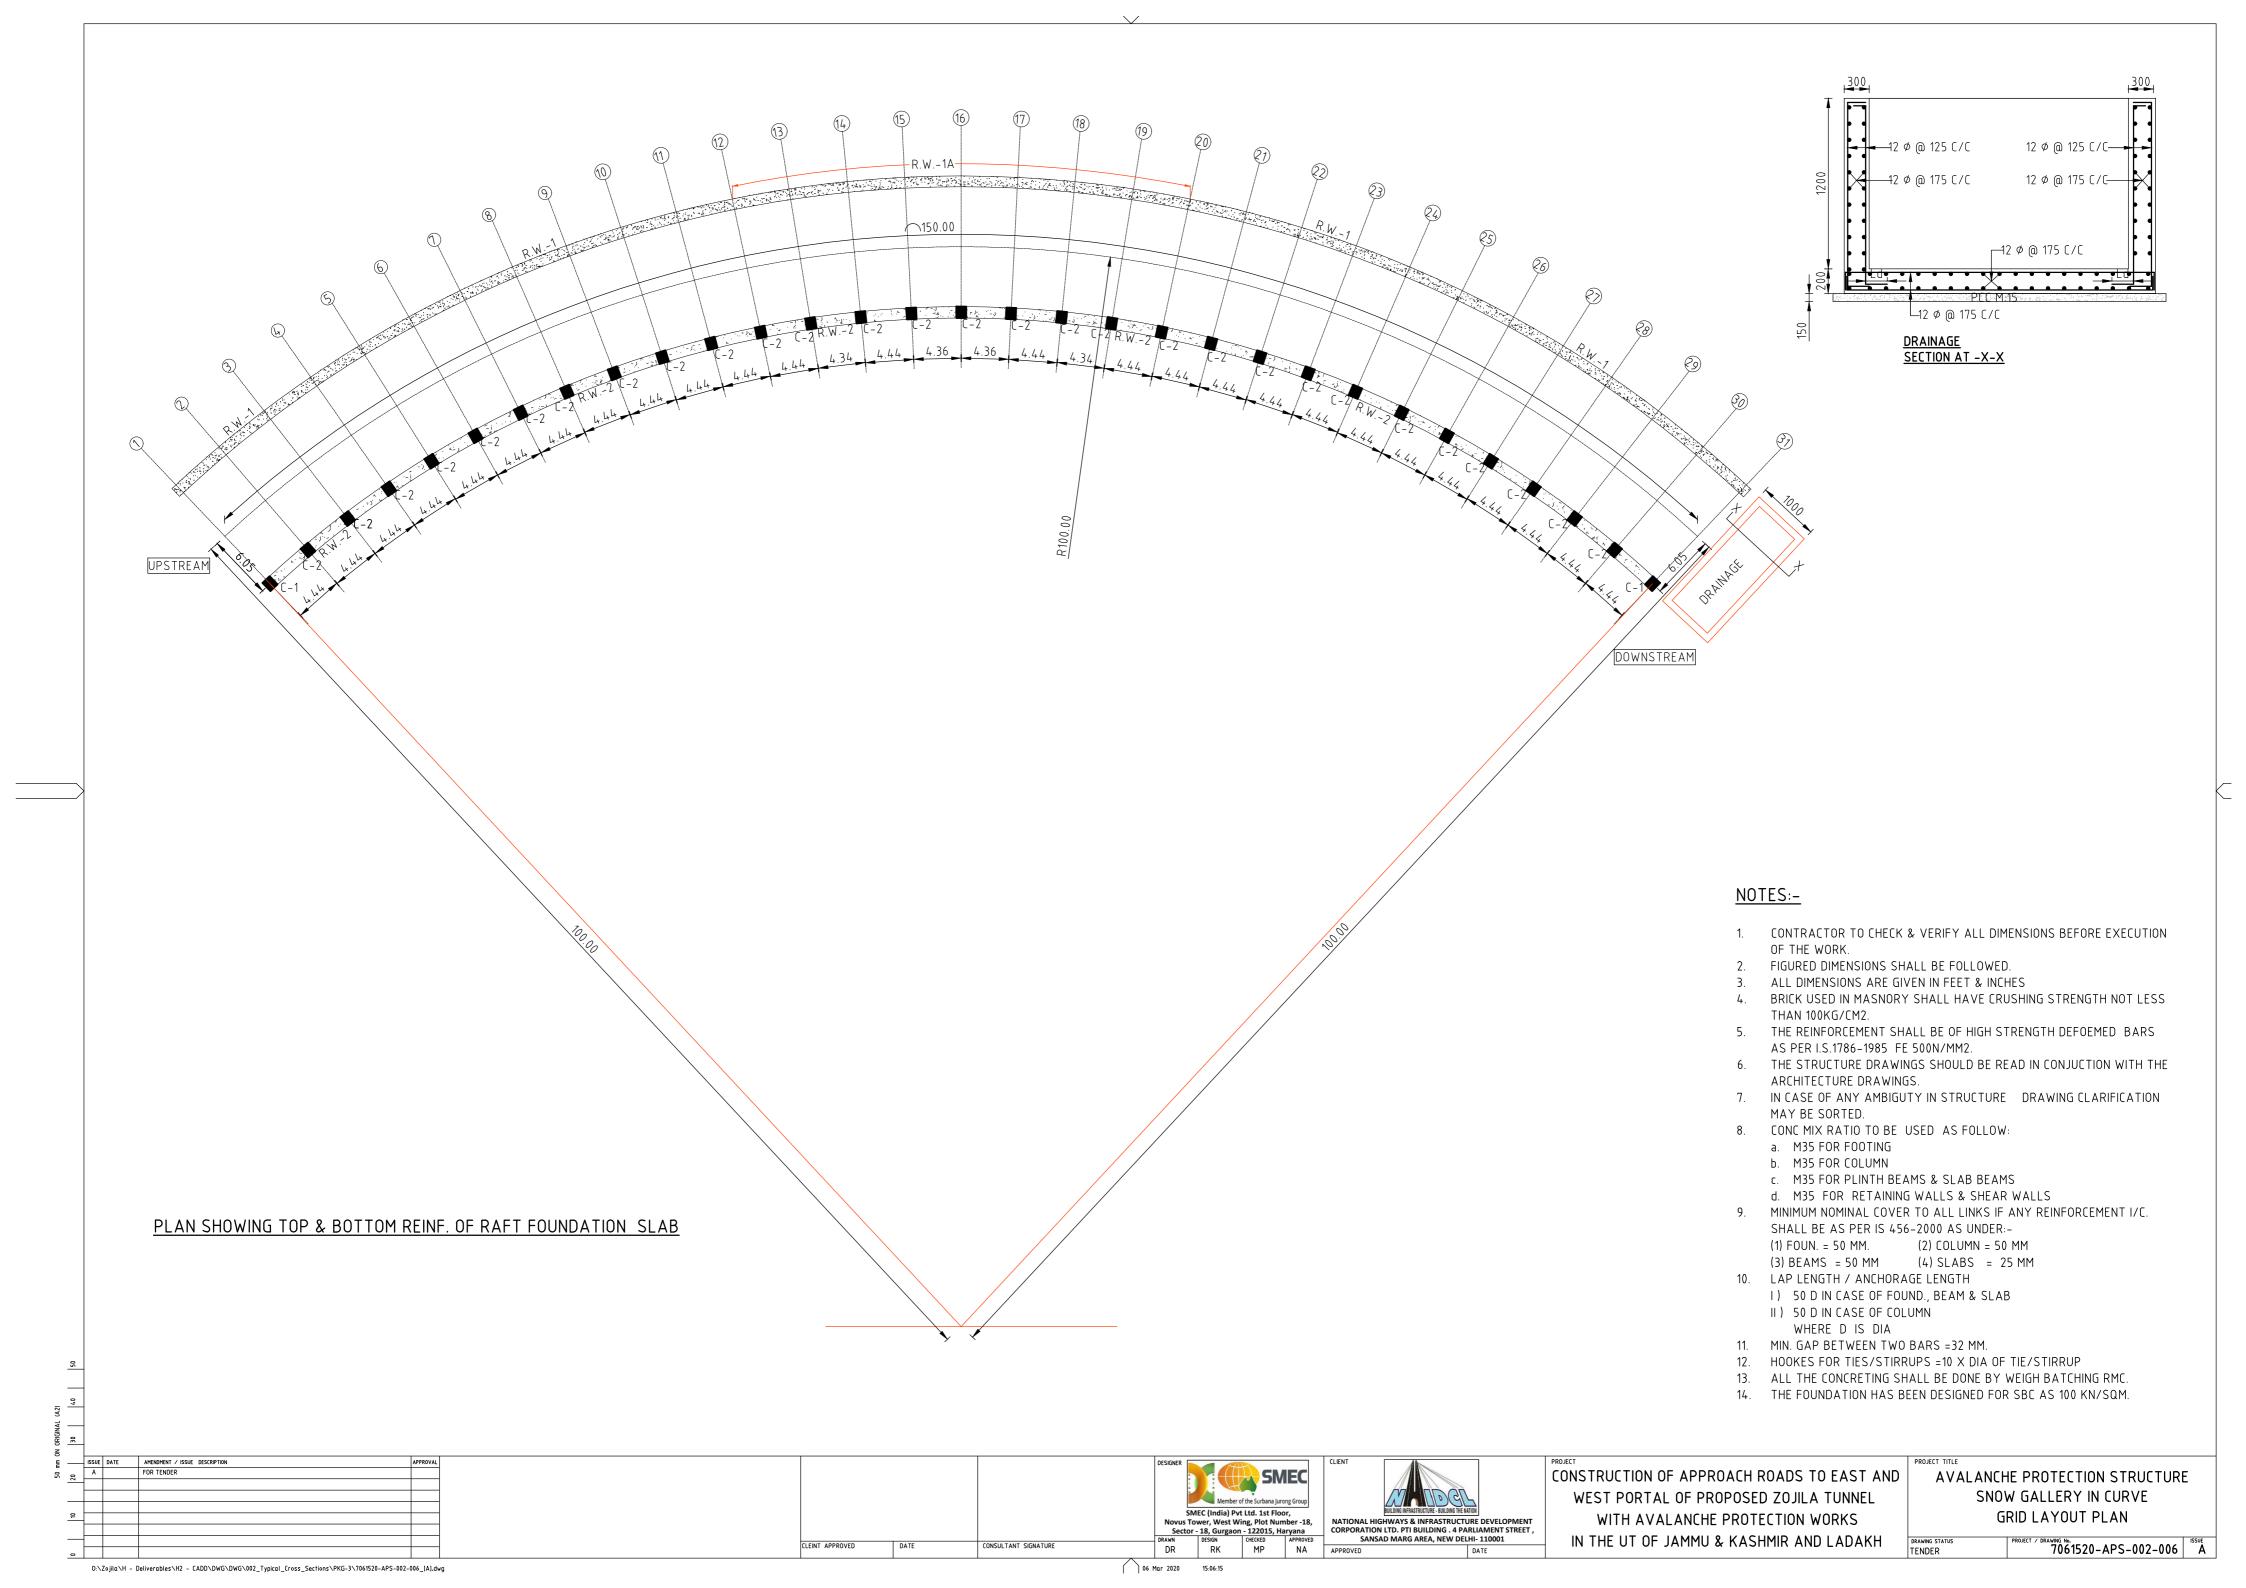

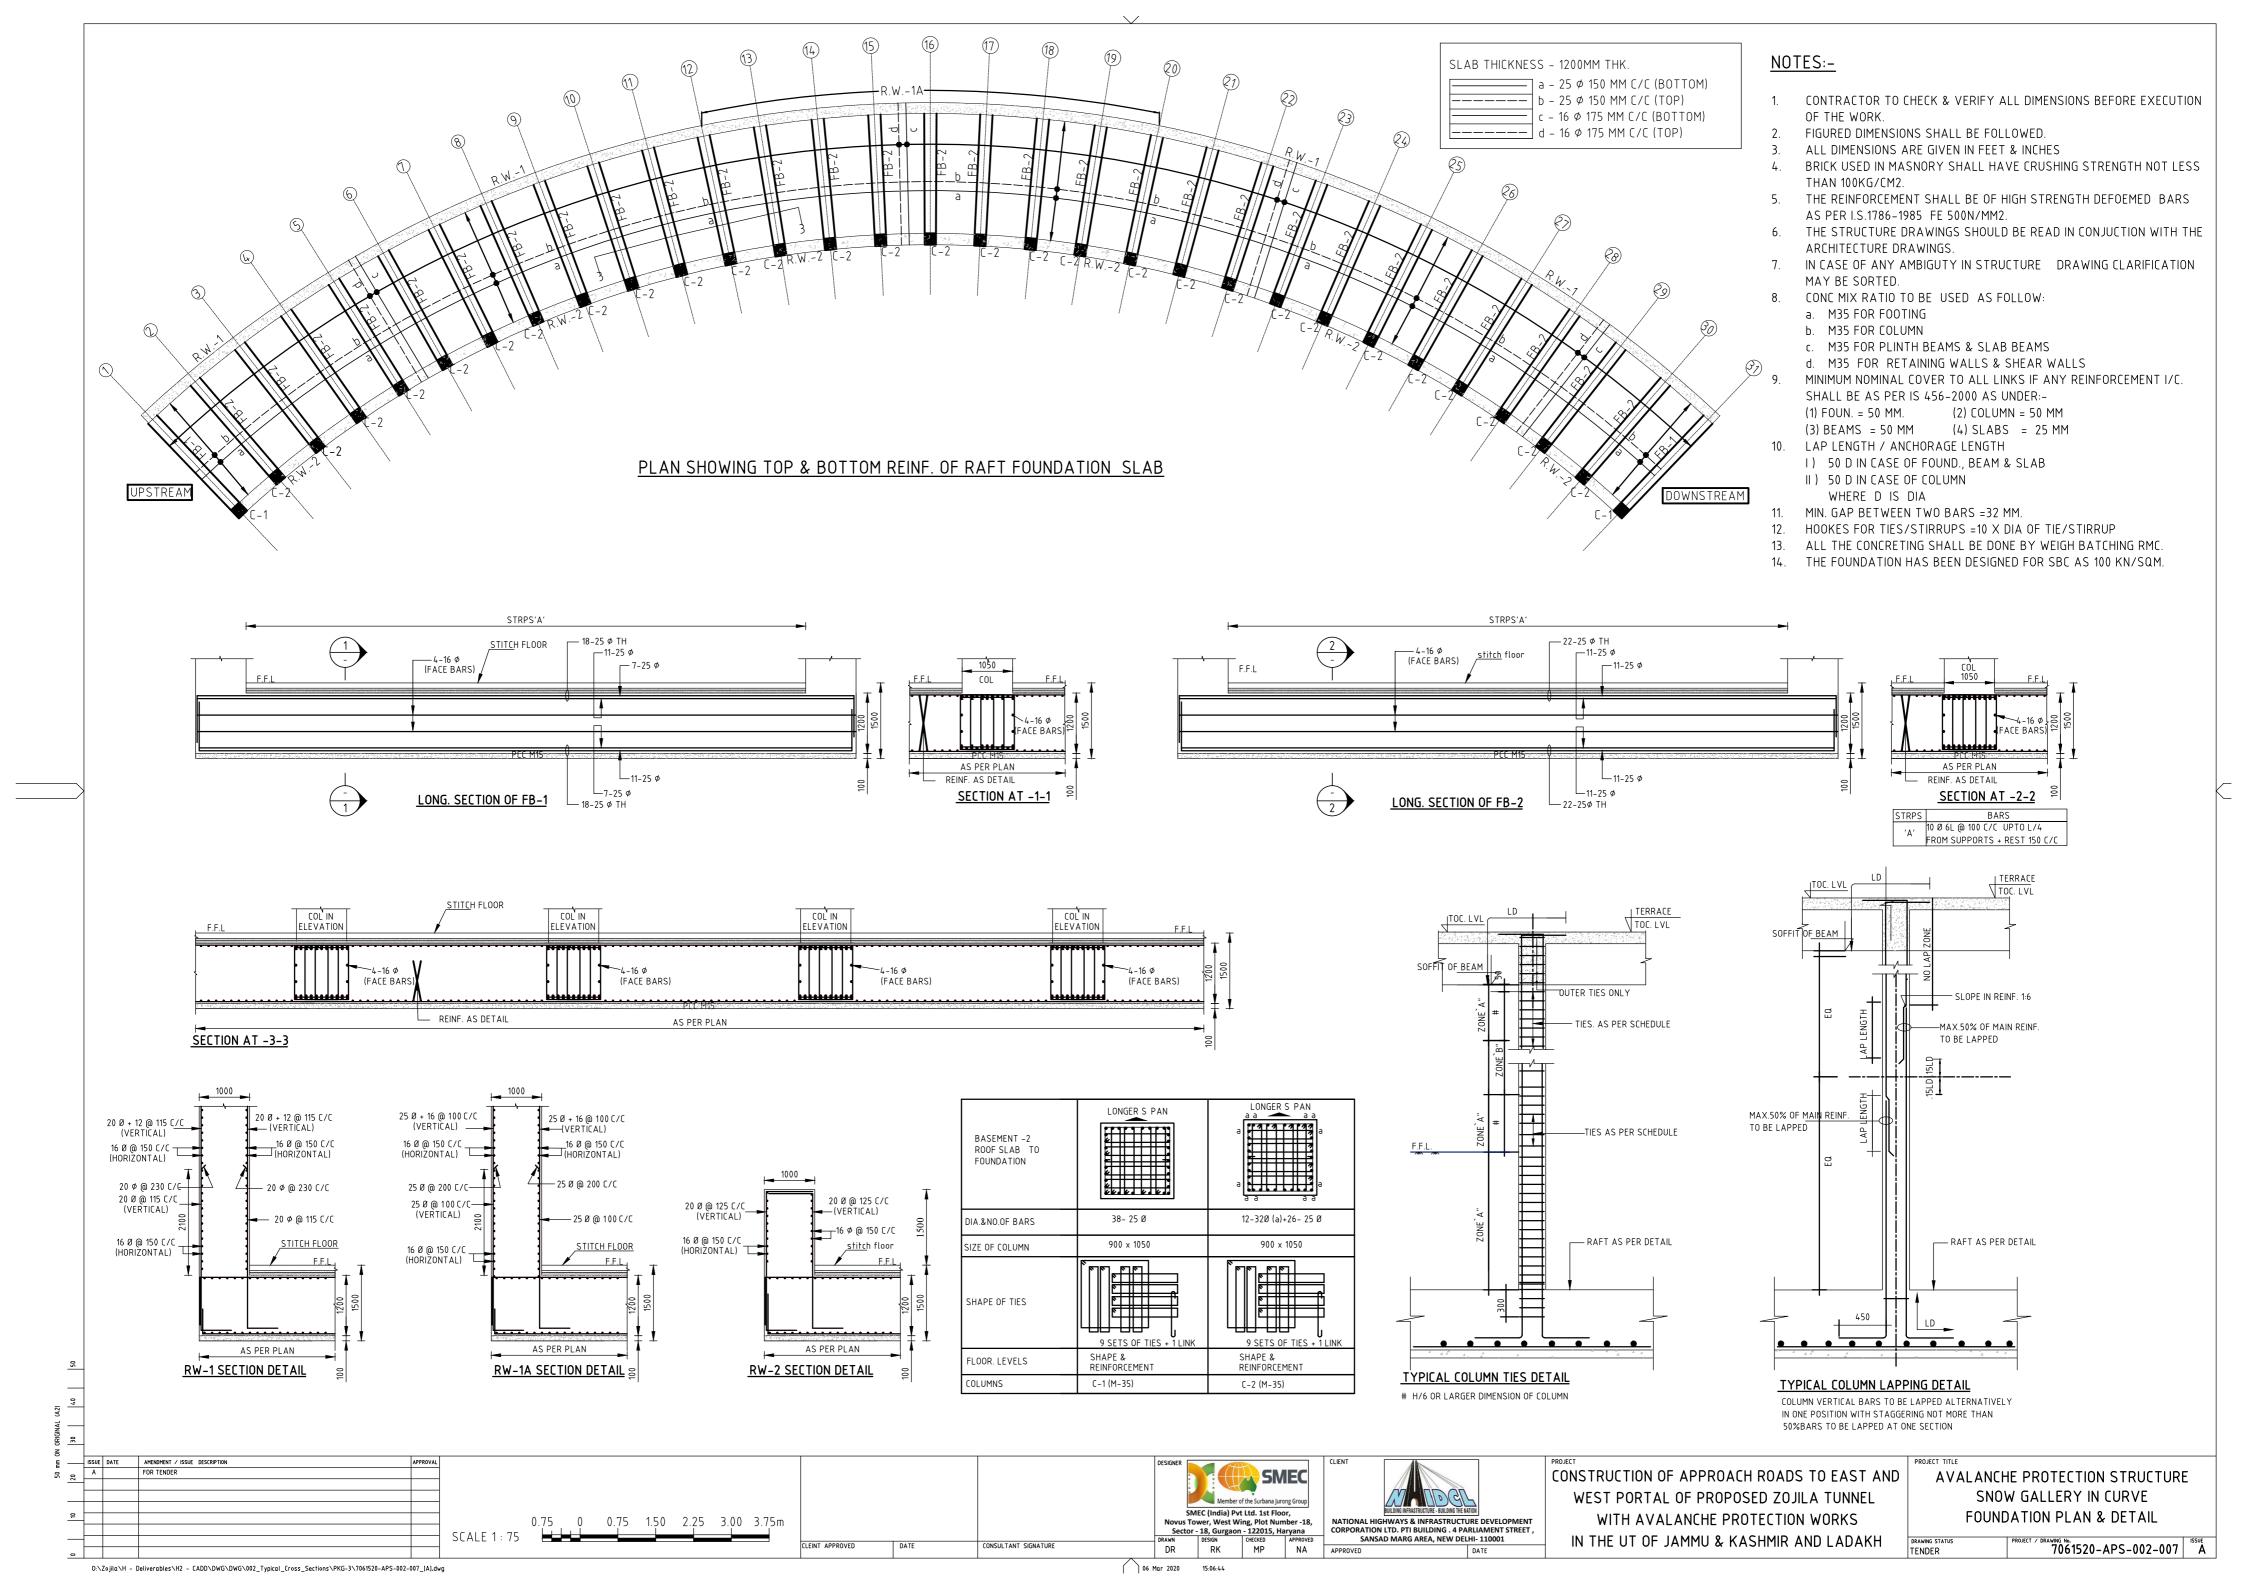

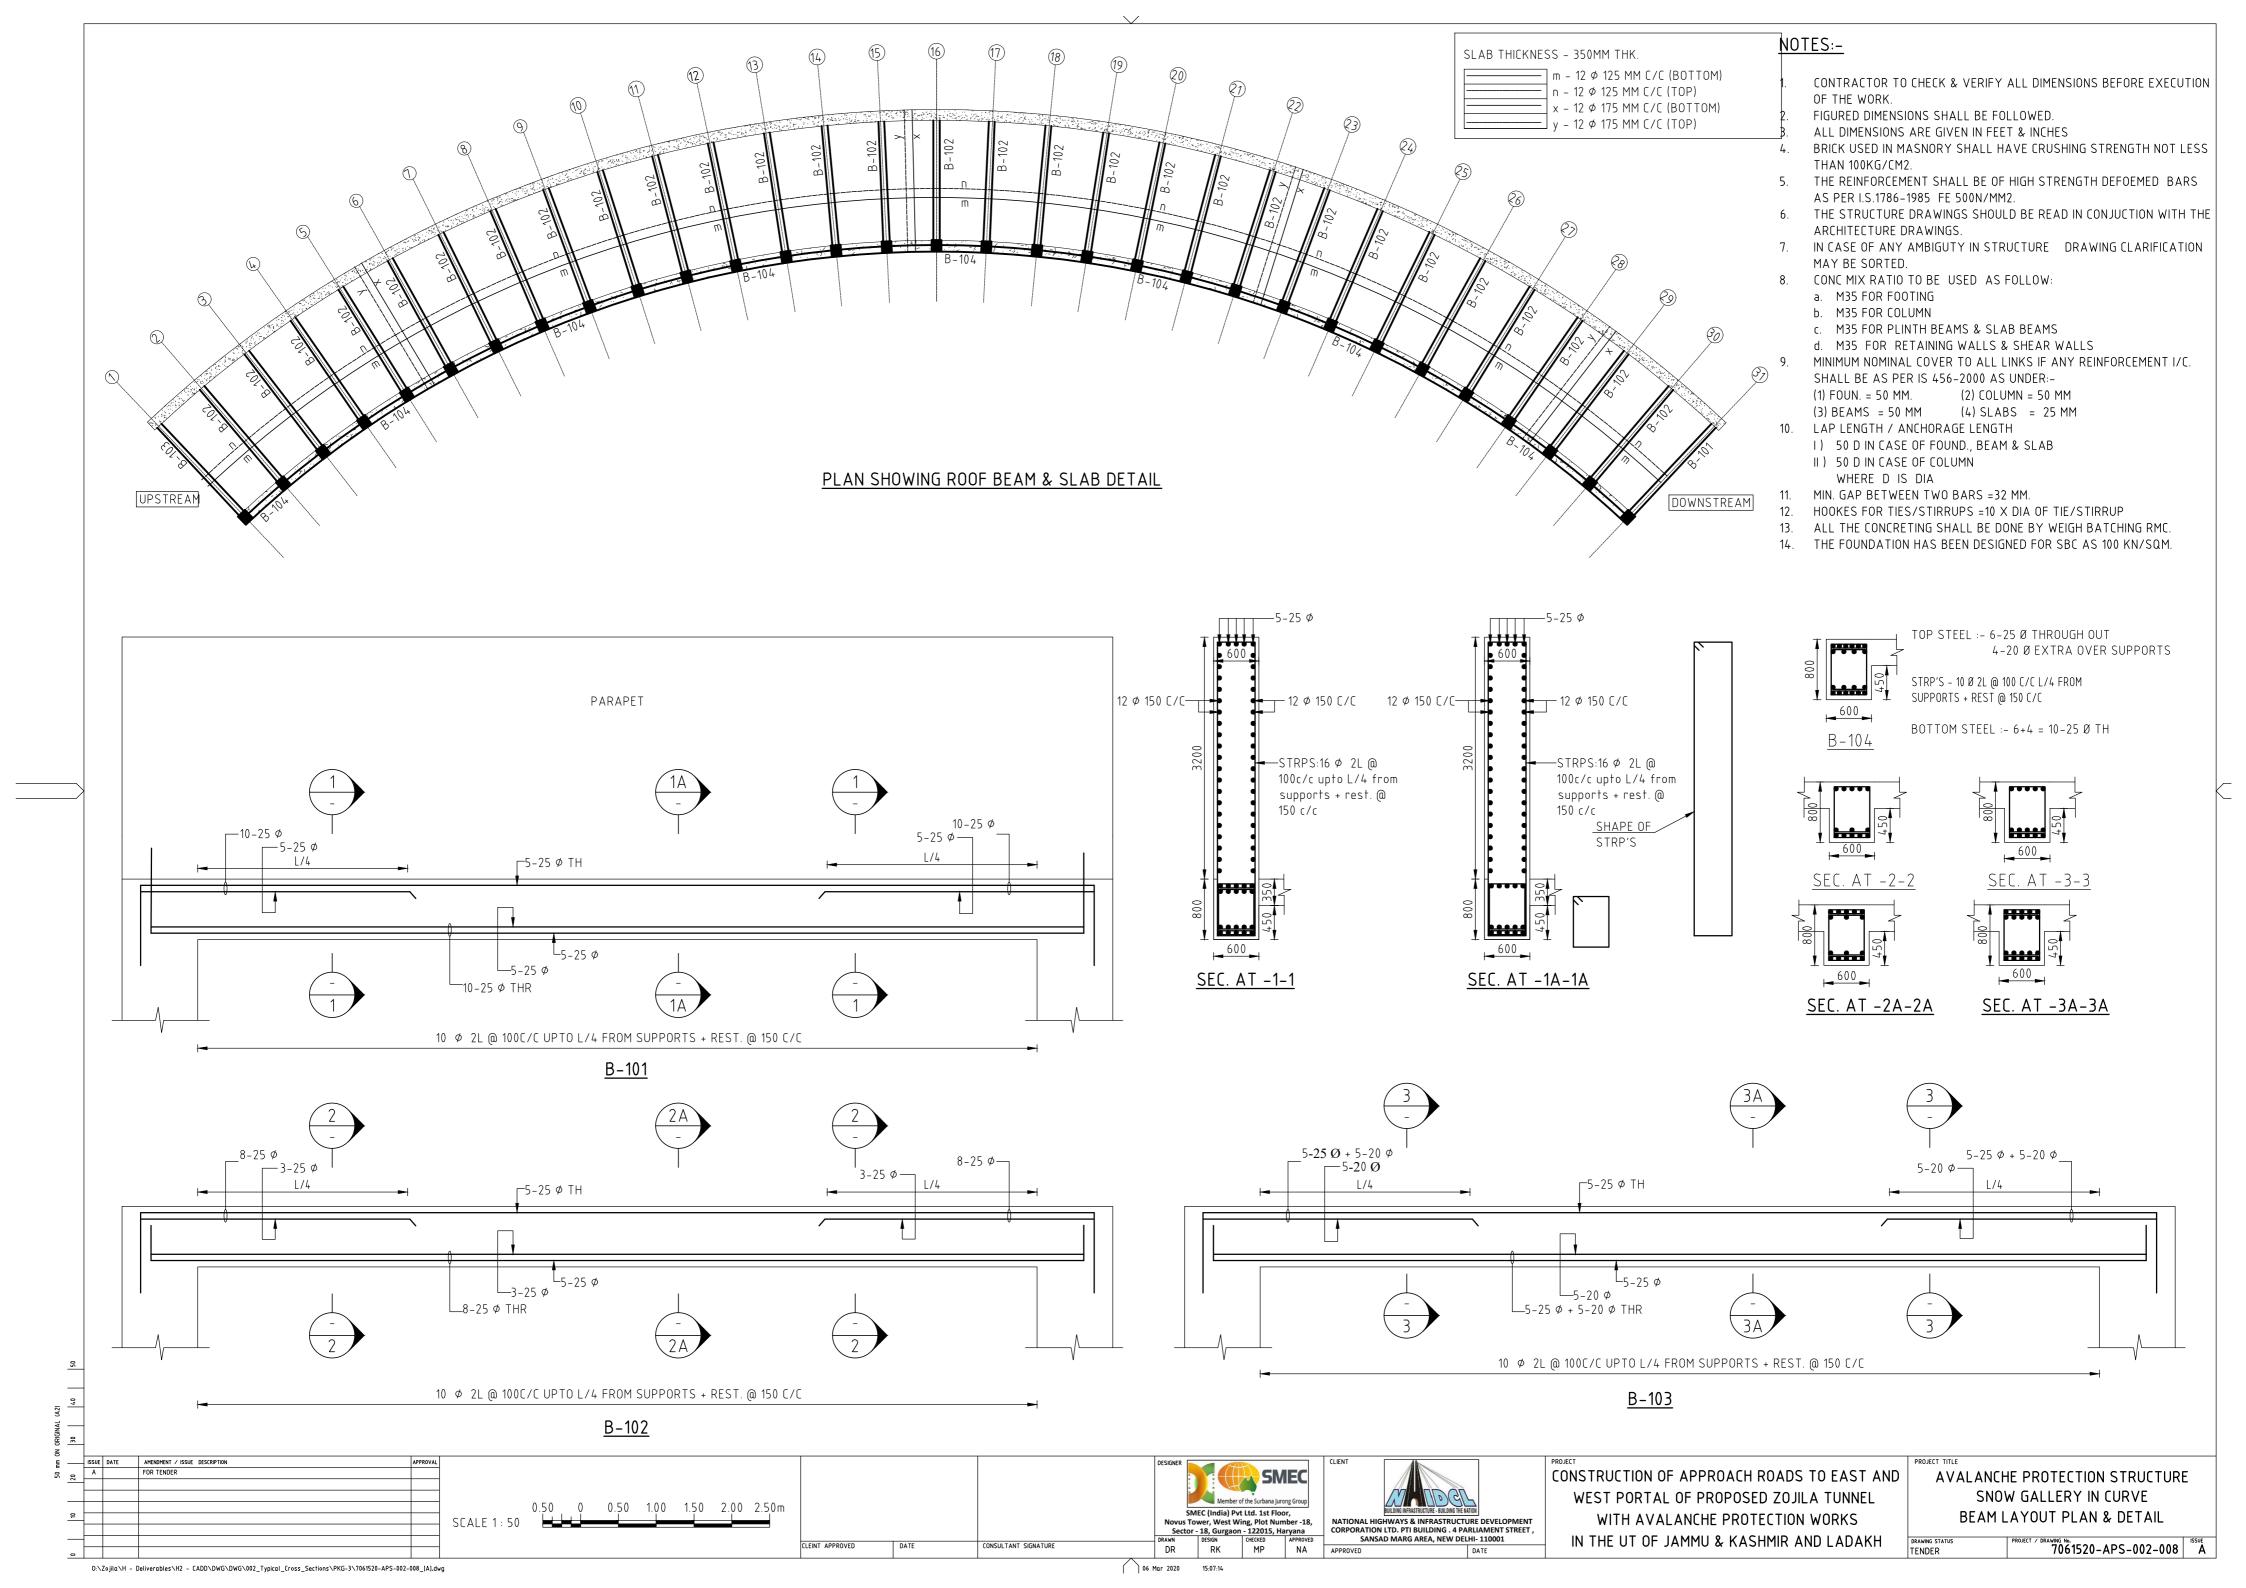

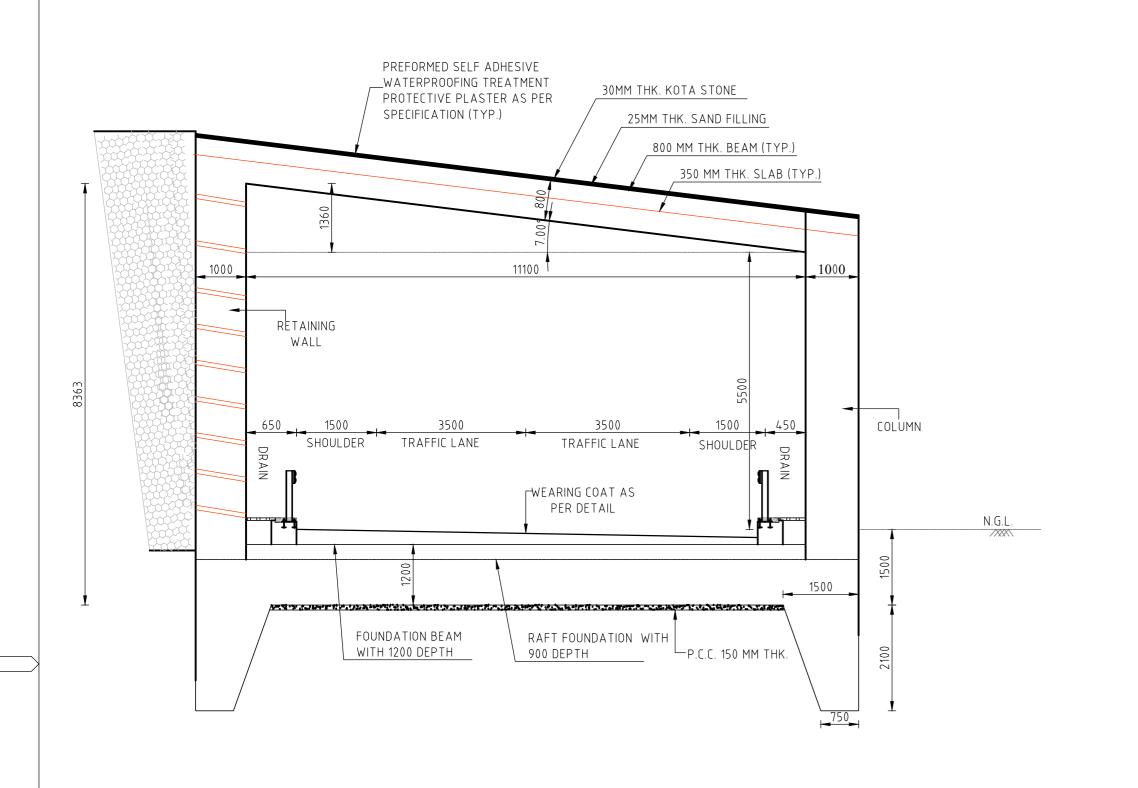

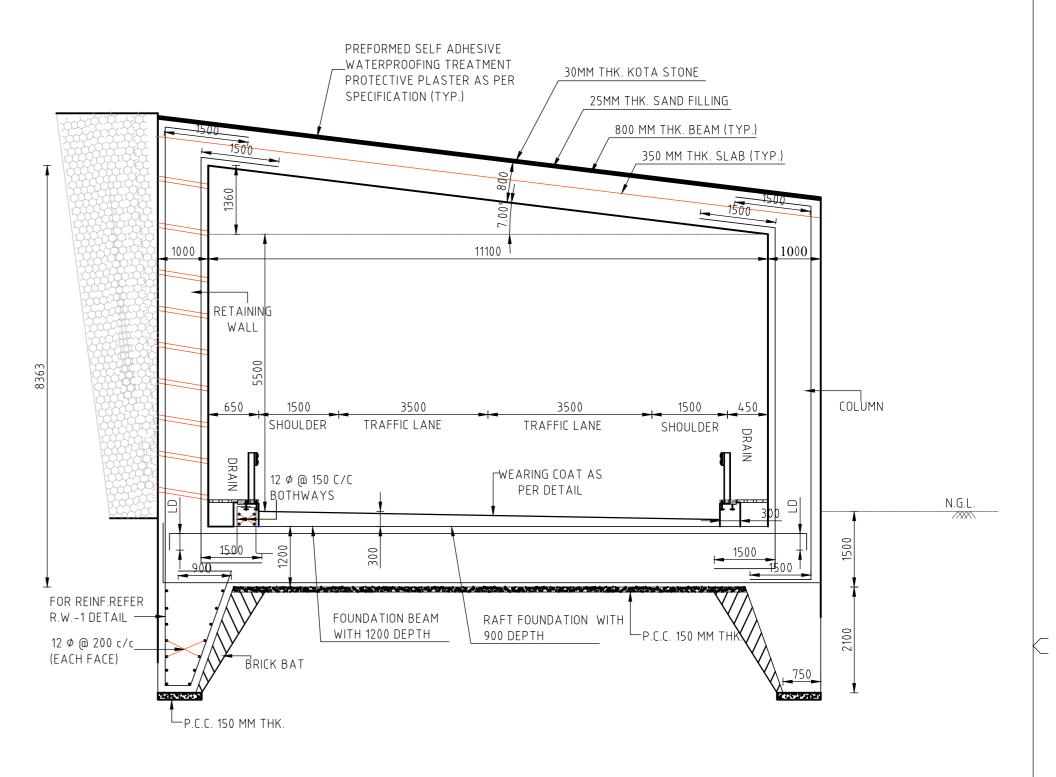

TYPICAL SECTION FOR SNOW GALLERY SL-46

06 Mar 2020 15:07:40

#### NOTES:-

- Contractor to Check & verify all dimensions before execution of the work.
- Figured dimensions shall be followed.
- All dimensions are given in FEET & INCHES
- Brick used in masnory shall have Crushing strength not less than 100kg/Cm2.
- The reinforcement shall be of high strength defoemed bars as per I.S.1786-1985 Fe 500N/mm2.
- The structure drawings should be read in Conjuction with the architecture drawings. In case of any ambiguty in structure drawing clarification may be sorted.
- 8. Conc mix ratio to be used as follow:
  - a. M35 for F00TING
  - b. M35 for COLUMN
  - c. M35 for plinth beams & slab beams
  - d. M35 for retaining walls & shear walls
- 9. MINIMUM NOMINAL COVER TO ALL LINKS IF ANY REINFORCEMENT I/C. SHALL BE AS PER IS 456-2000 AS UNDER:-(1) FOUN. = 50 mm. (2) COLUMN = 50 mm (3) BEAMS = 50 mm (4) SLABS = 25 mm
- 10. LAP LENGTH / ANCHORAGE LENGTH
  - i) 50 d IN CASE OF FOUND., BEAM & SLAB
  - ii ) 50 d IN CASE OF COLUMN WHERE d IS DIA
- 11. MIN. GAP BETWEEN TWO BARS =32 MM.
- HOOKES FOR TIES/STIRRUPS = 10 X DIA OF TIE/STIRRUP
- 13. ALL THE CONCRETING SHALL BE DONE BY WEIGH BATCHING RMC.
- THE FOUNDATION HAS BEEN DESIGNED FOR SBC AS 100 KN/SQM.


A SOUR DATE AMENDMENT / ISSUE DESCRIPTION
A FOR TENDER SMEC 0.75 0 0.75 1.50 2.25 3.00 3.75m SCALE 1 : 75 SMEC (India) Pvt Ltd. 1st Floor, | Novus Tower, West Wing, Plot Number -18, | Sector - 18, Gurgaon - 122015, Haryana | DRAWN | DESIGN | CHECKED | APPROVED | DR | RK | MP | NA | APPROVED | APPROVED | APPROVED | CHECKED | CLEINT APPROVED CONSULTANT SIGNATURE


 $0: \label{local_coss_sections} O: \label{local_coss_sections} PKG-3 \ \ 7061520-APS-002-009\_[A]. dwg$ 


NATIONAL HIGHWAYS & INFRASTRUCTURE DEVELOPMENT CORPORATION LTD. PTI BUILDING . 4 PARLIAMENT STREET , SANSAD MARG AREA, NEW DELHI- 110001


CONSTRUCTION OF APPROACH ROADS TO EAST AND WEST PORTAL OF PROPOSED ZOJILA TUNNEL WITH AVALANCHE PROTECTION WORKS IN THE UT OF JAMMU & KASHMIR AND LADAKH


AVALANCHE PROTECTION STRUCTURE SNOW GALLERY CROSS SECTION DETAIL 7061520-APS-002-009 A

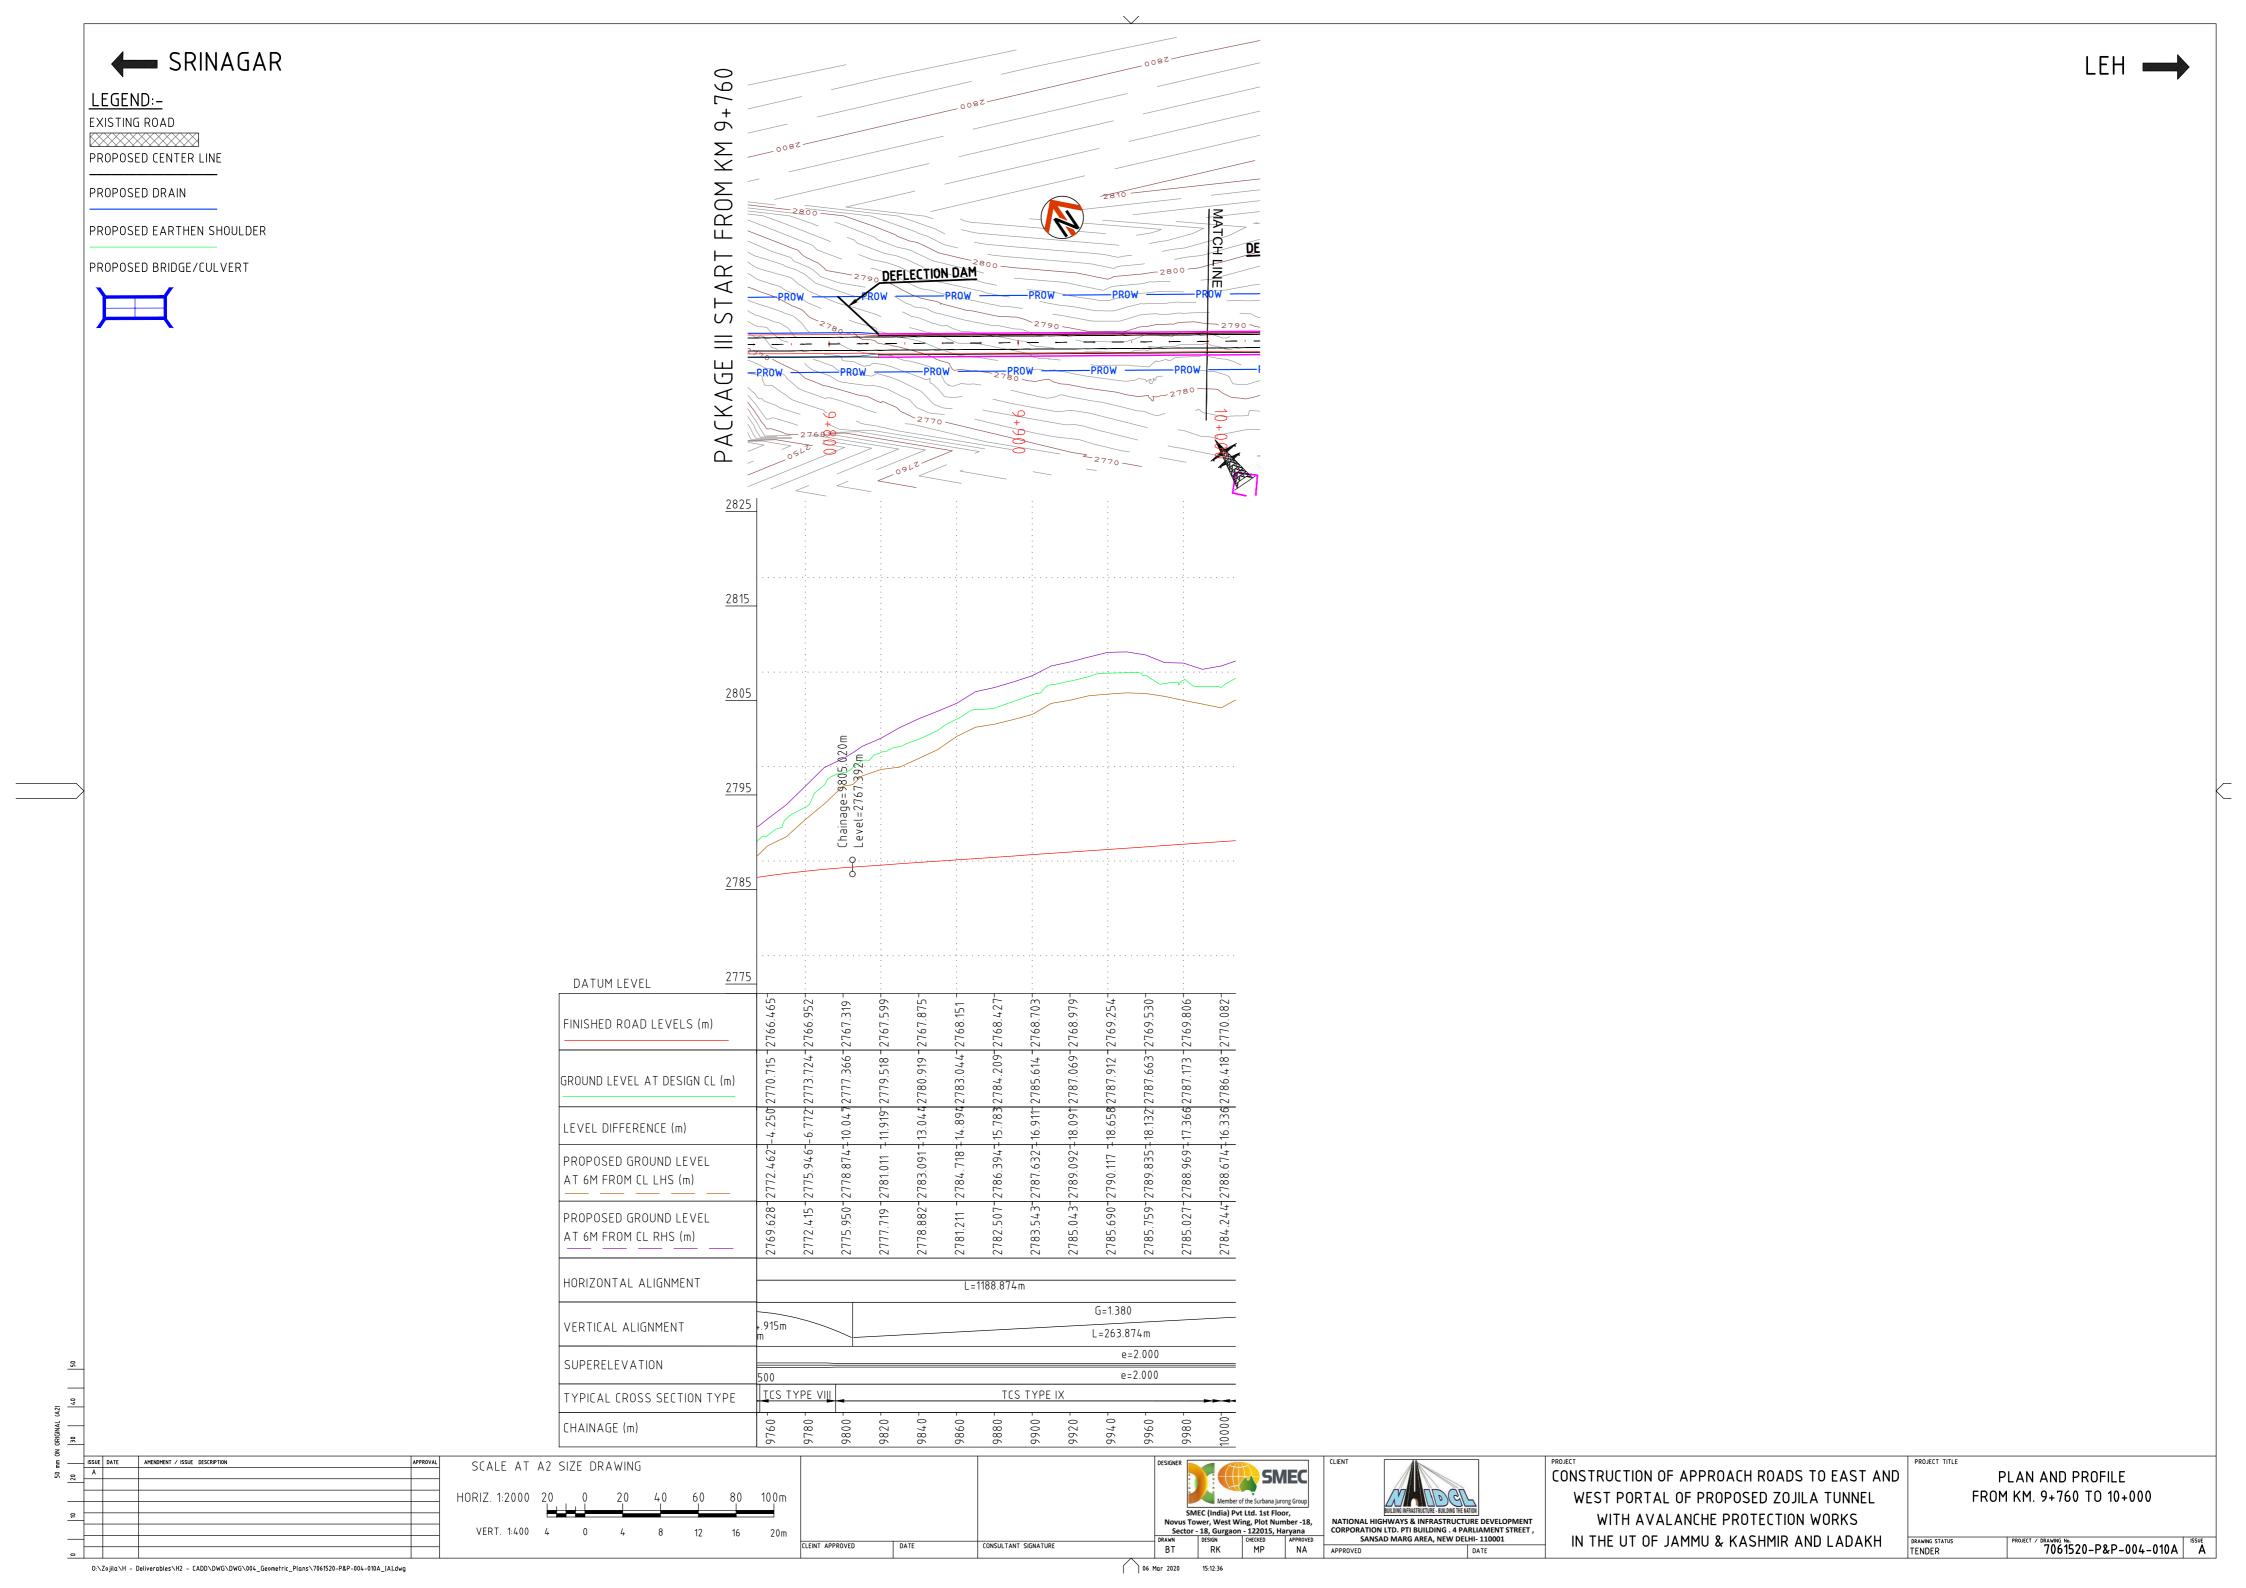


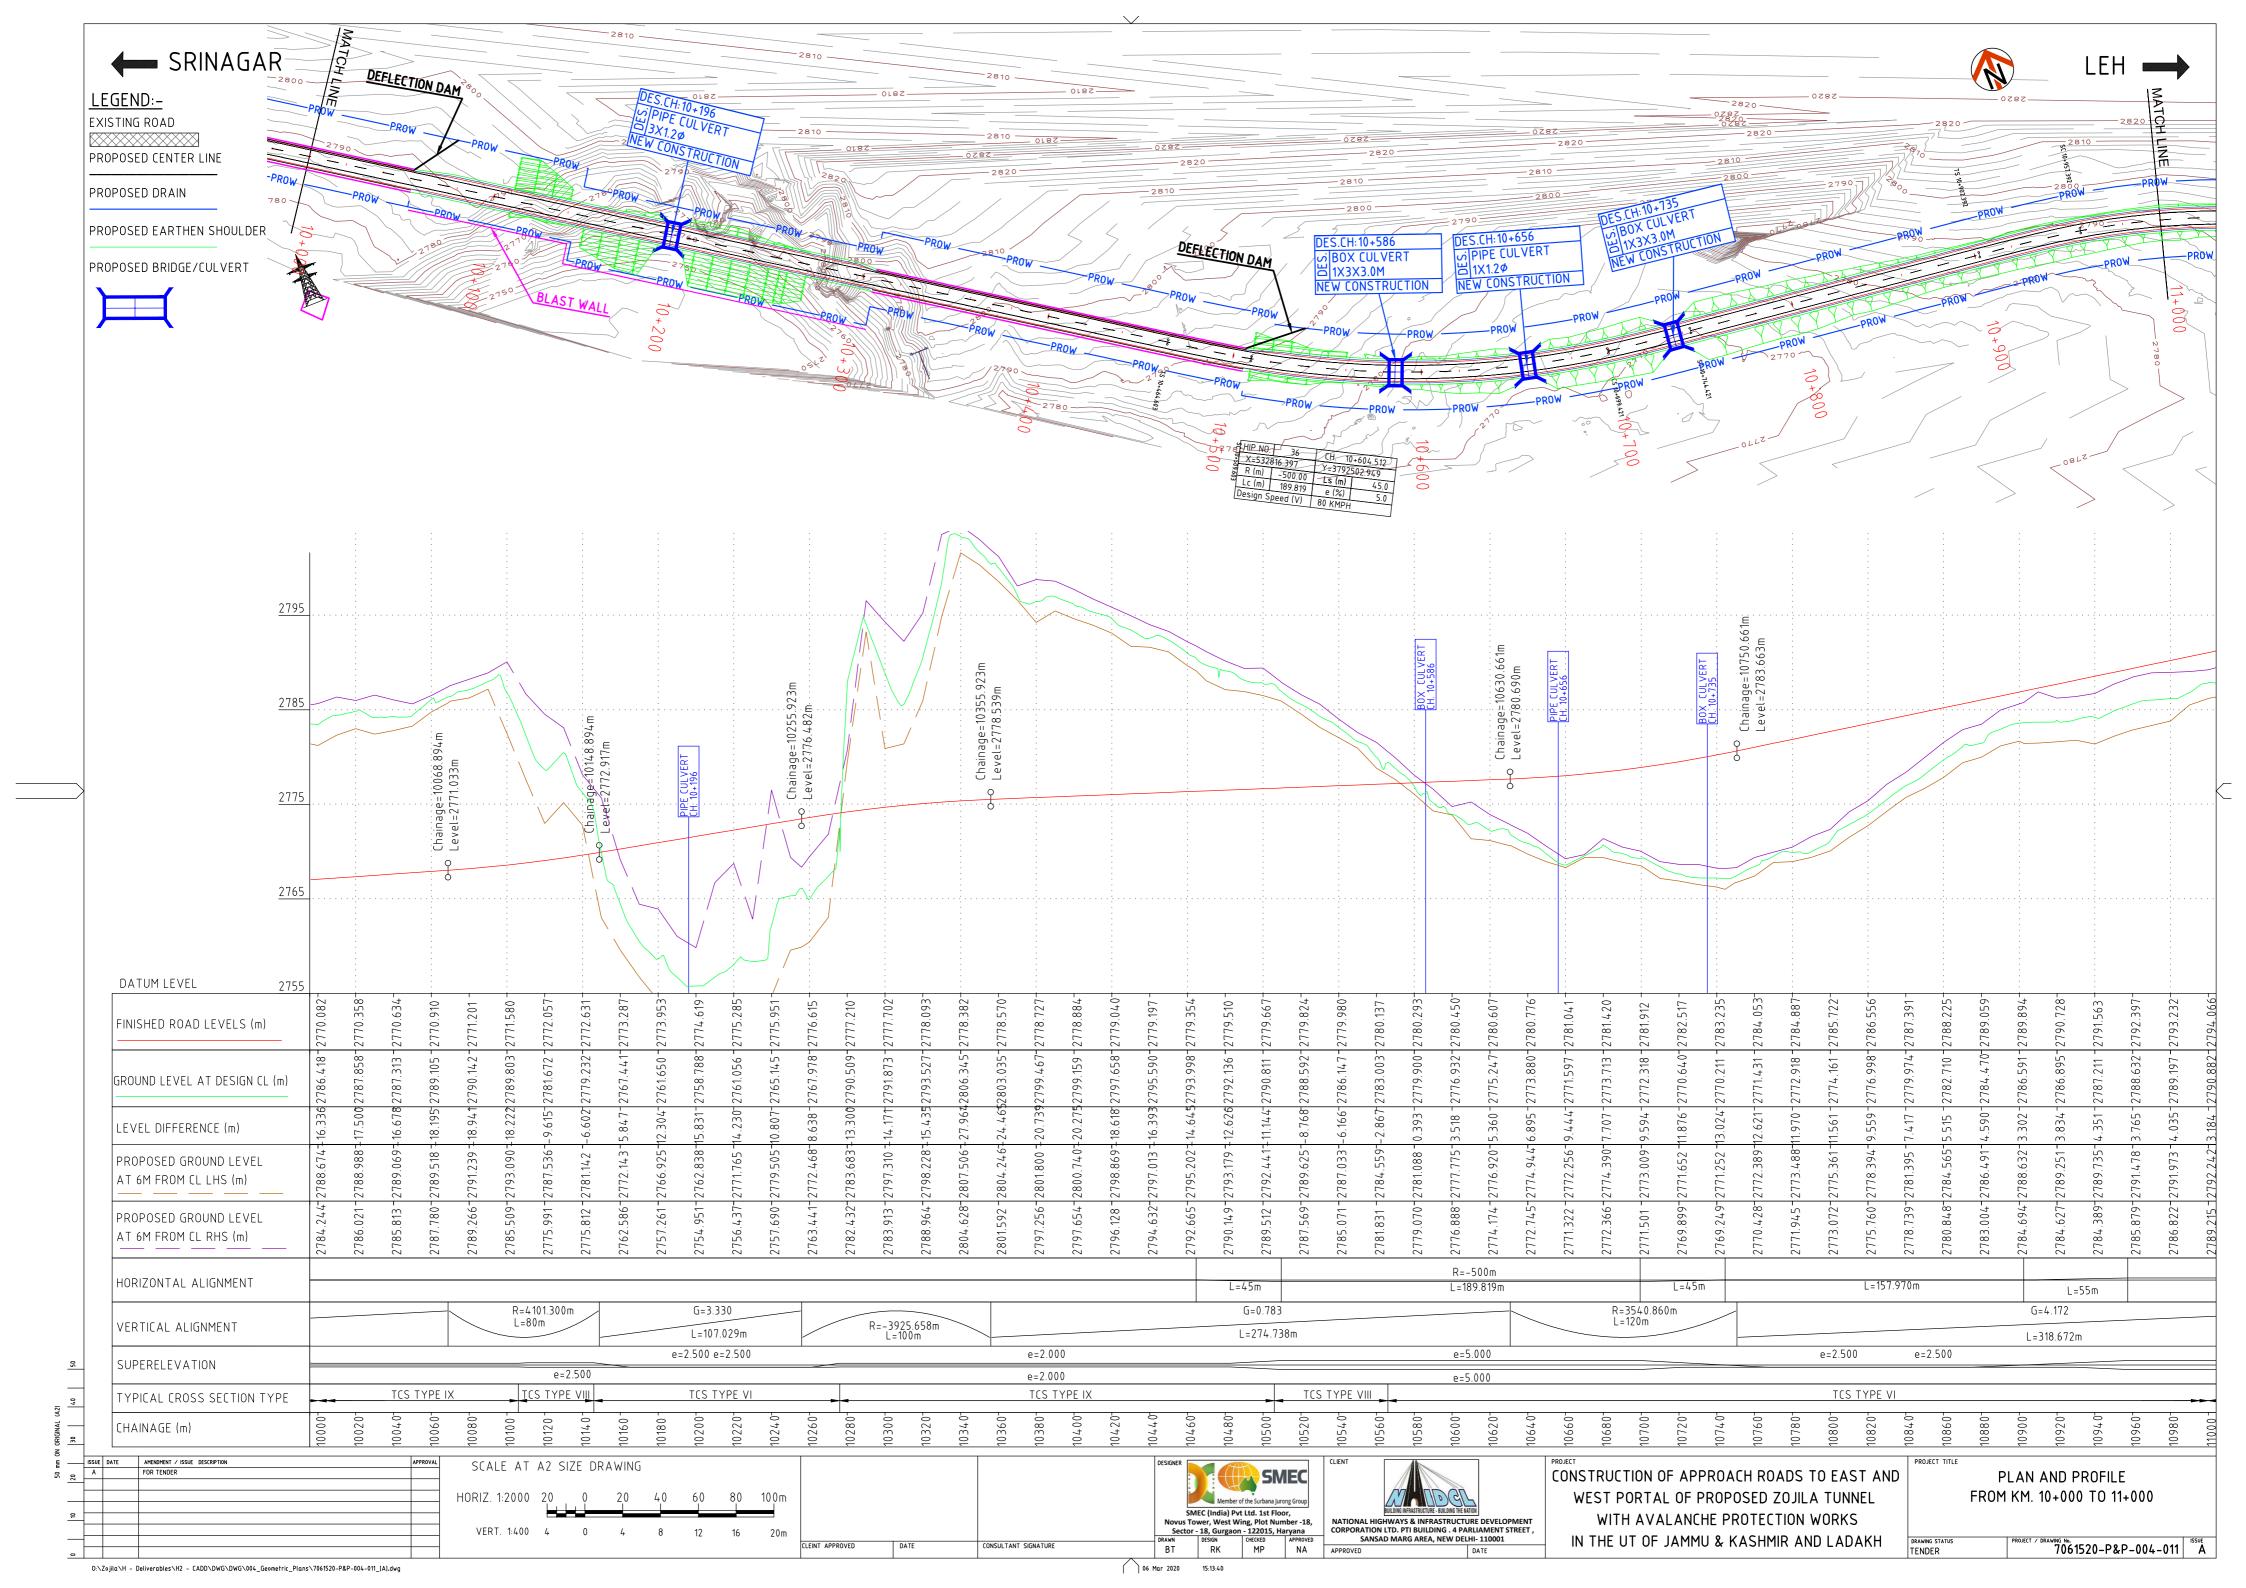


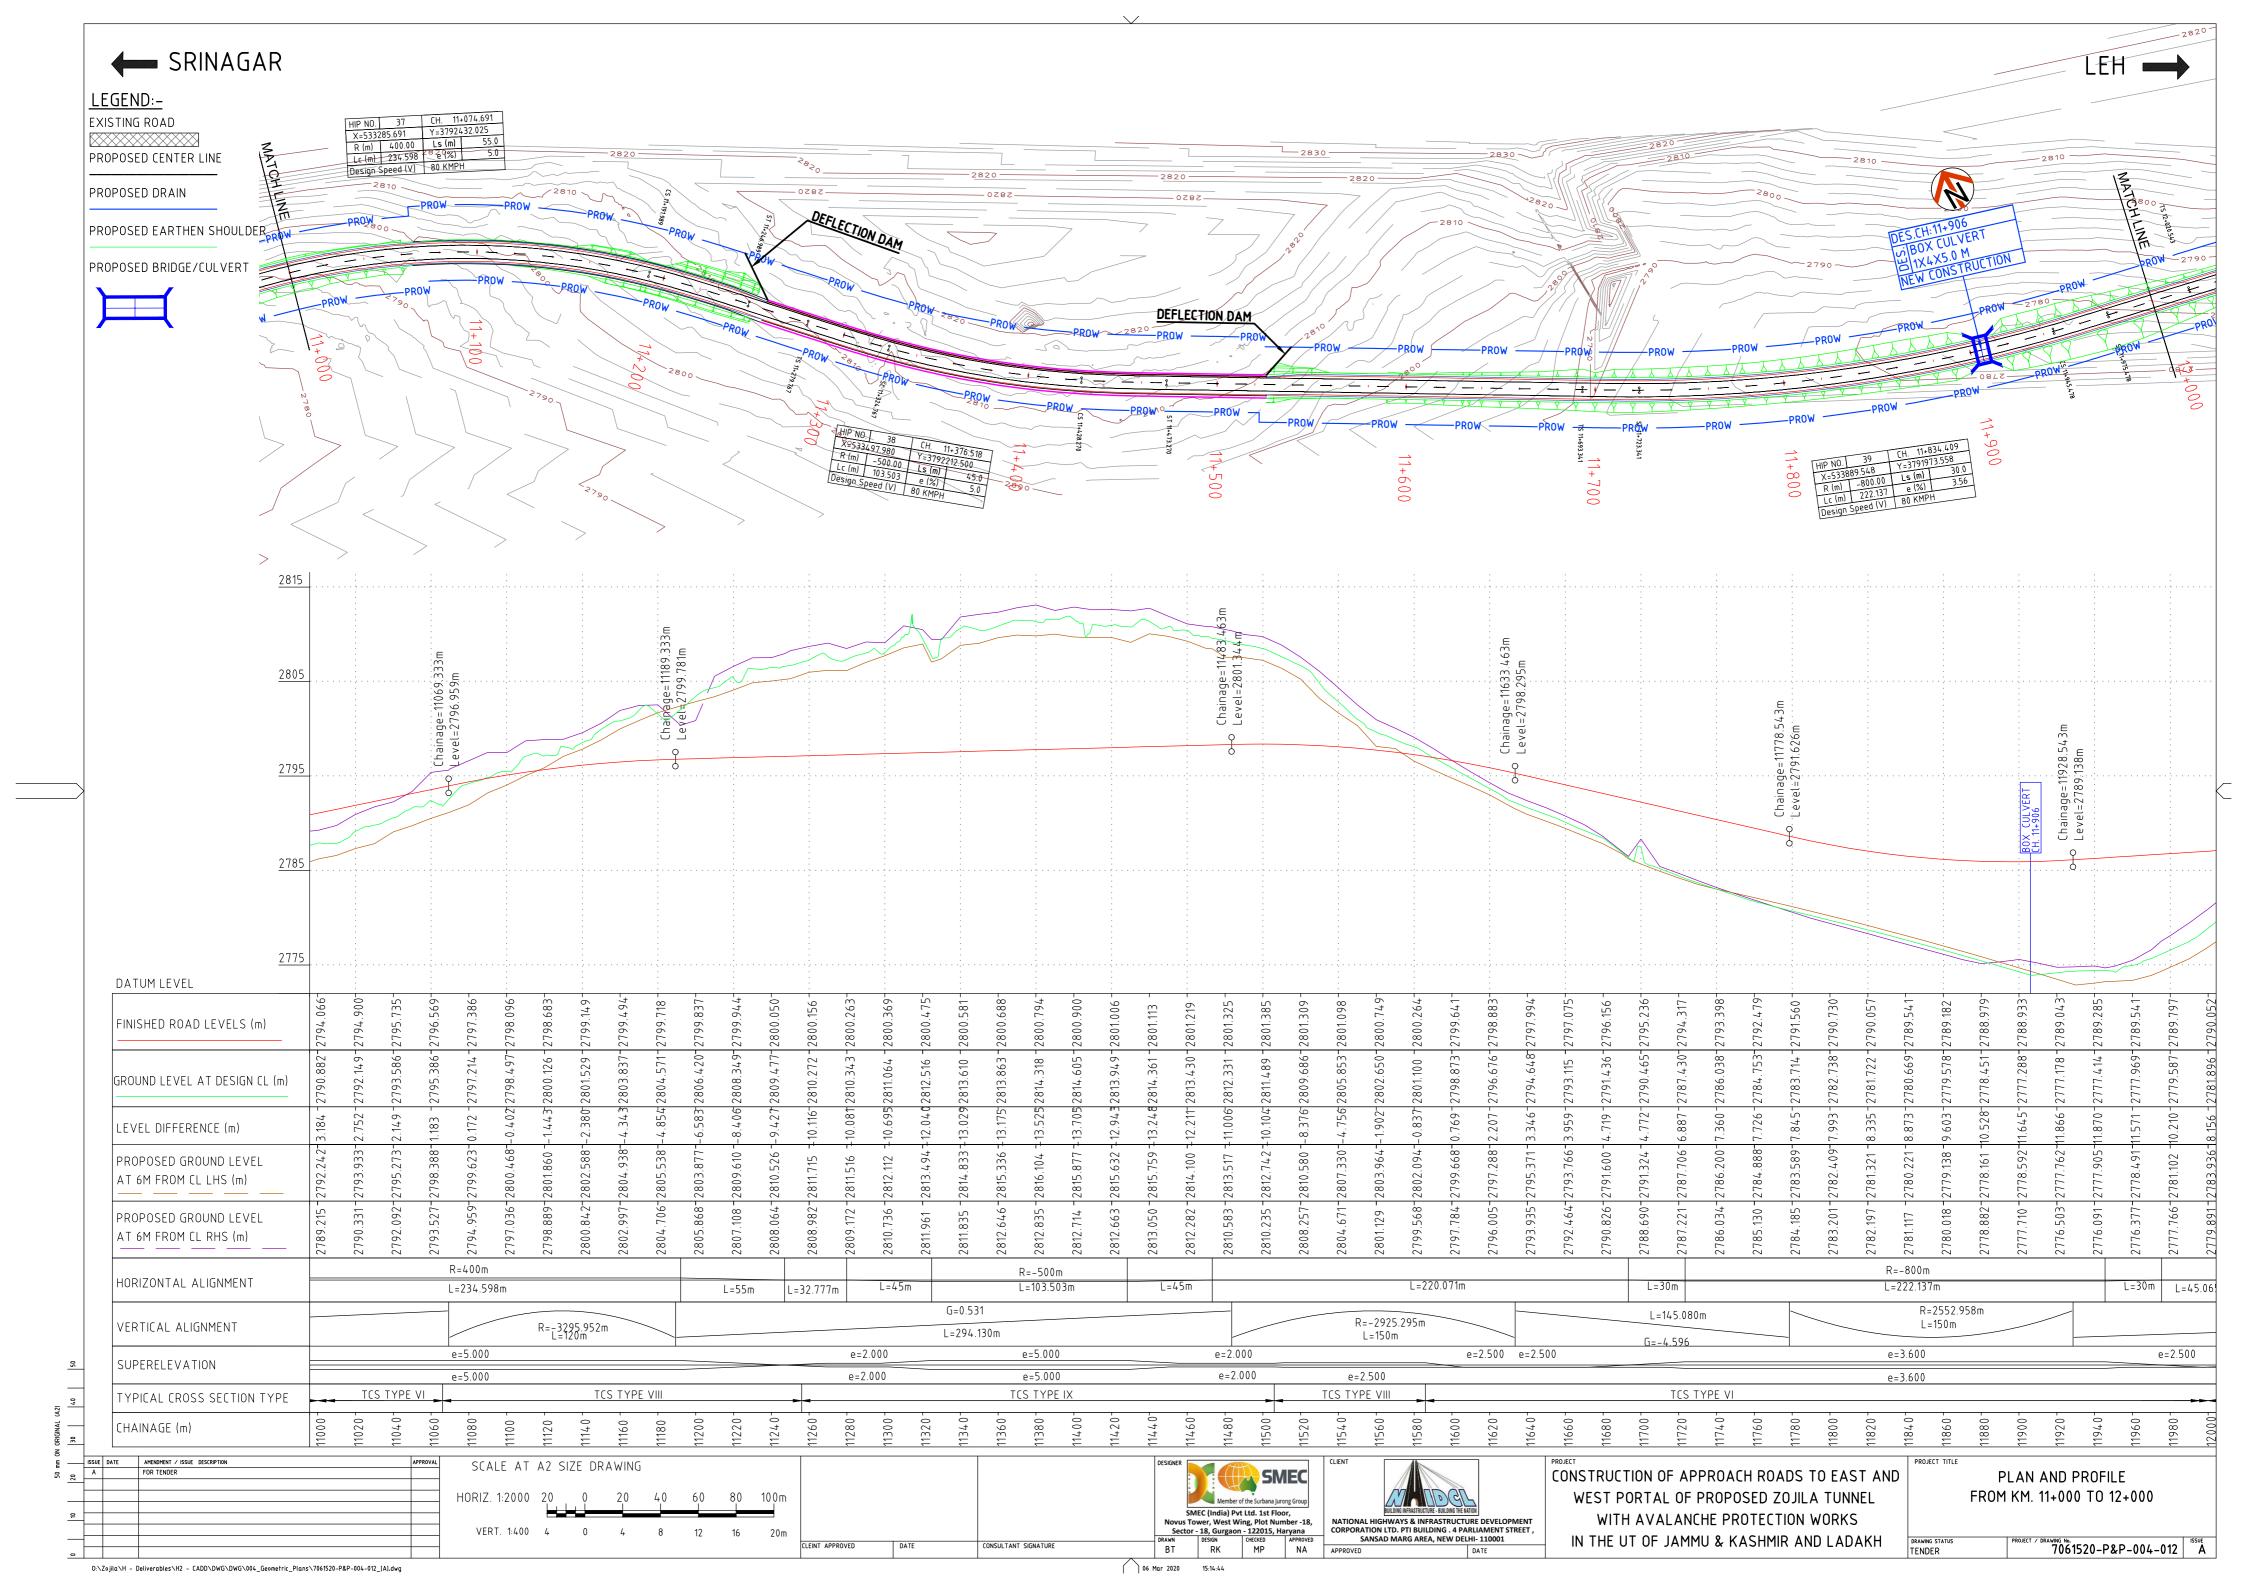


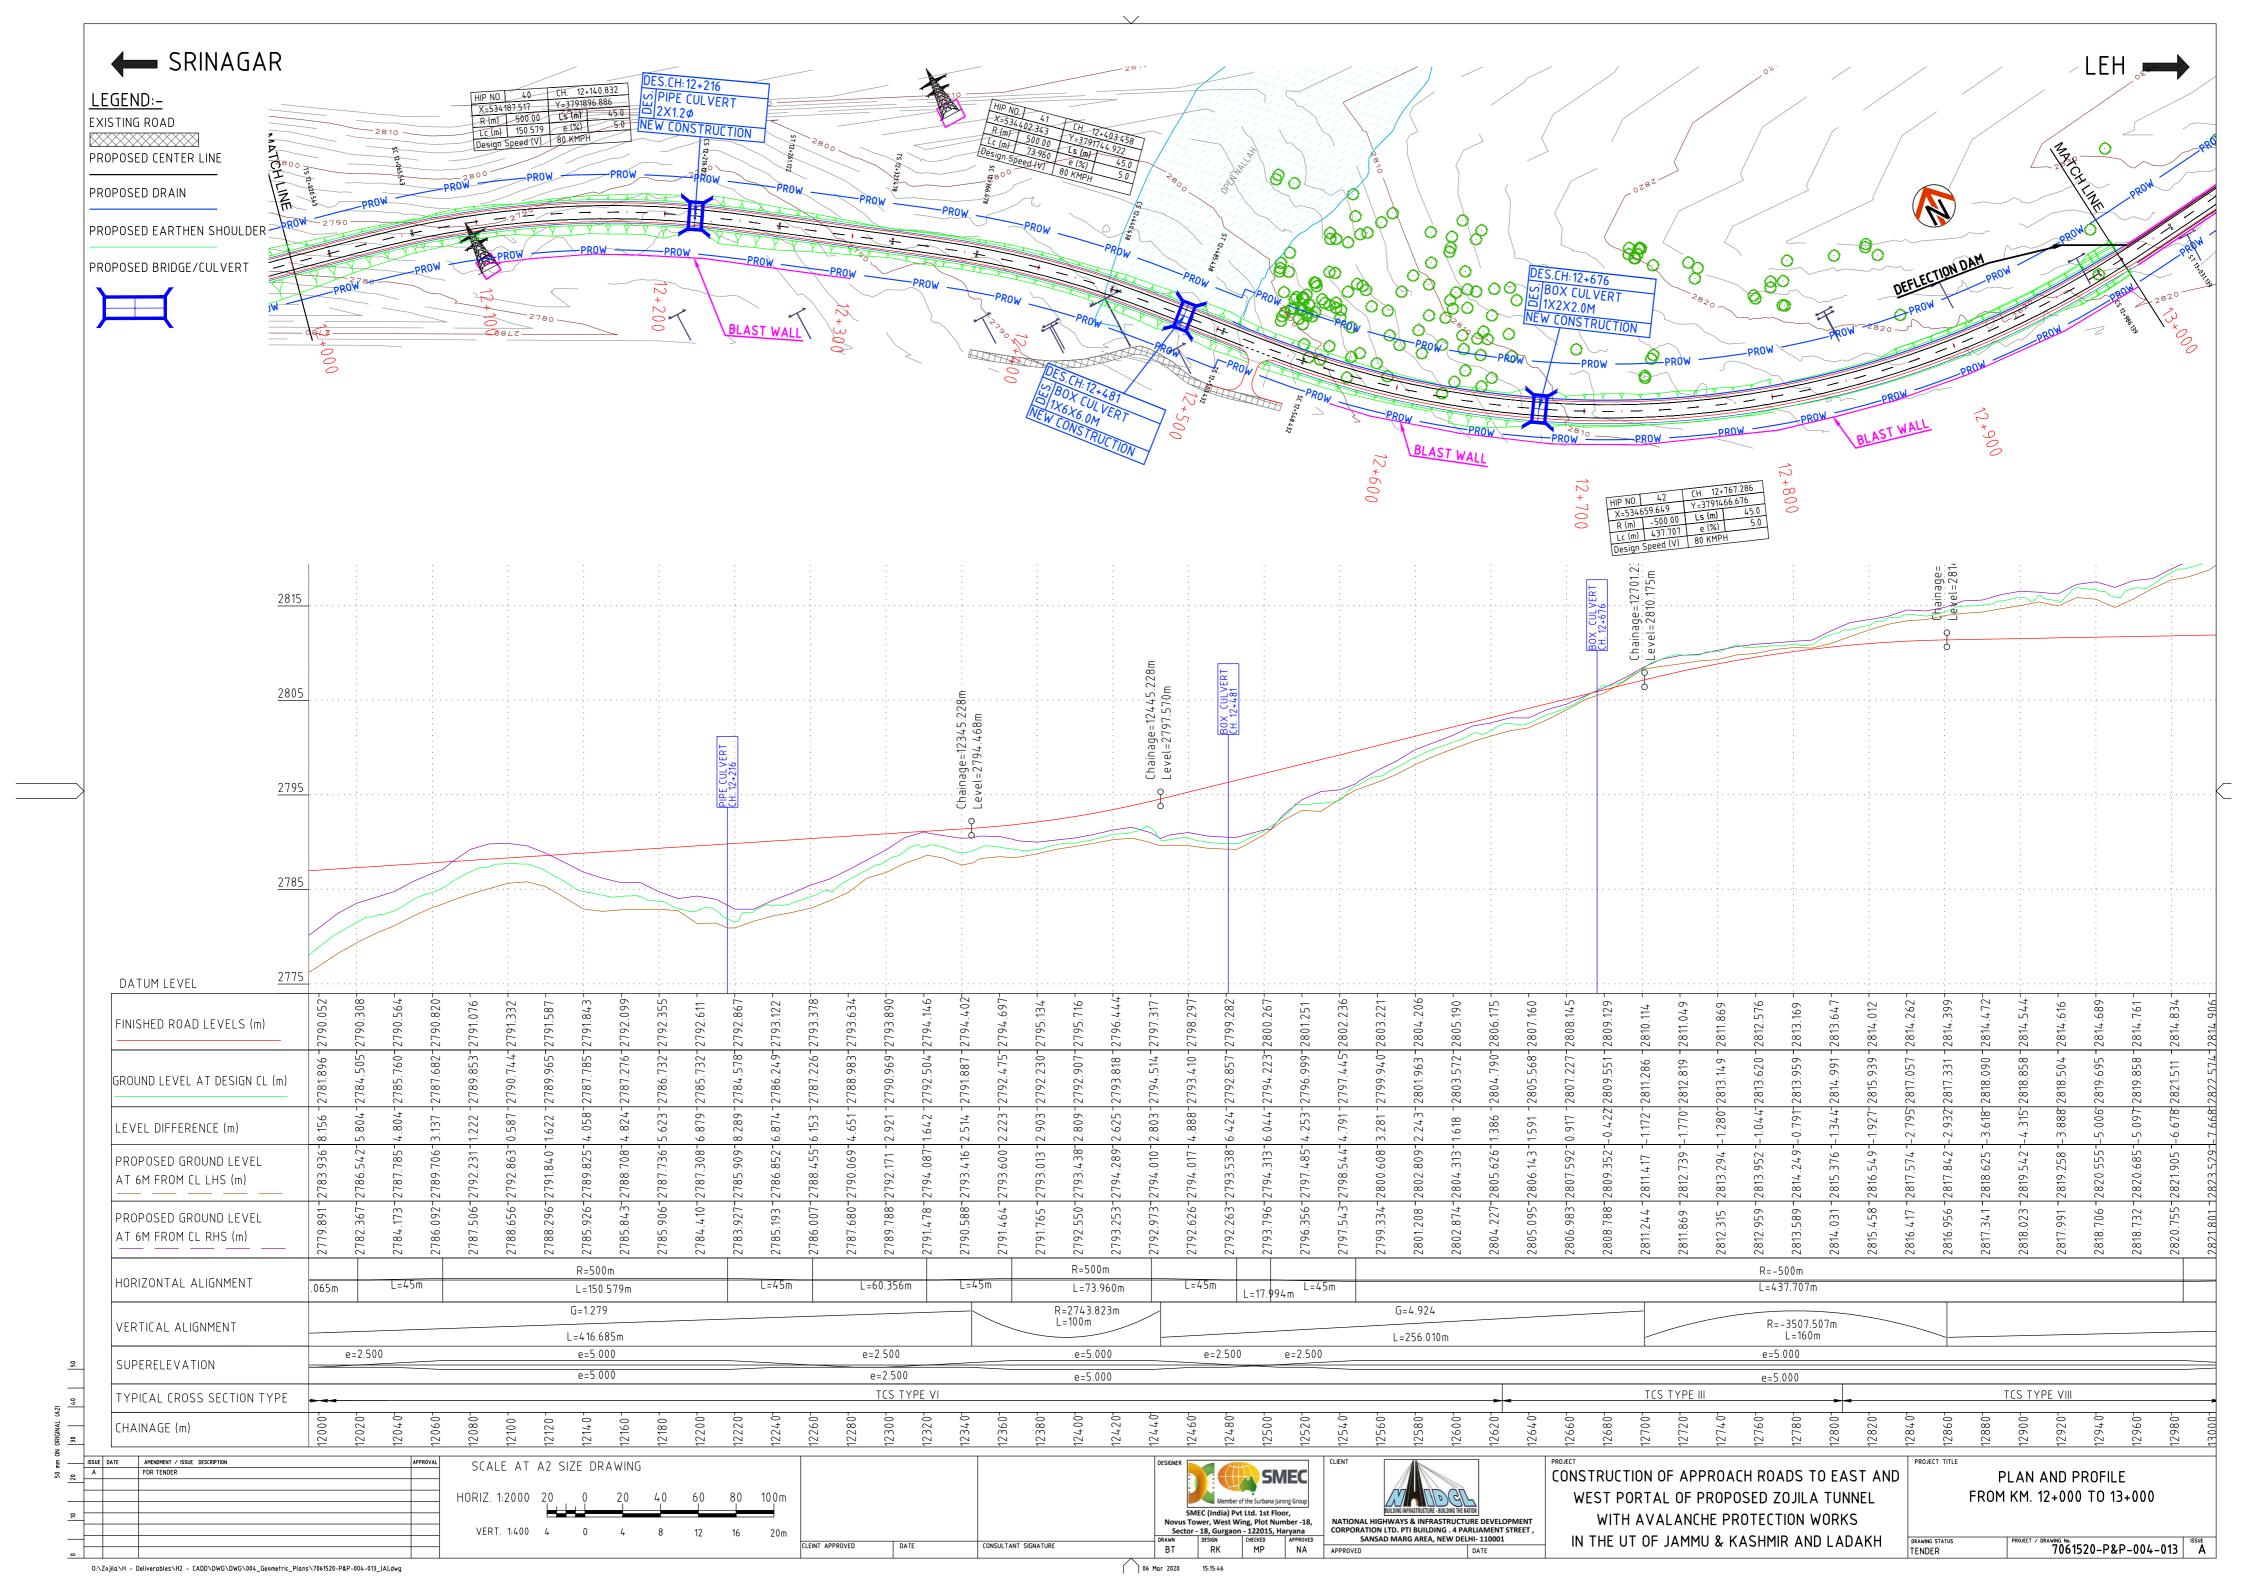


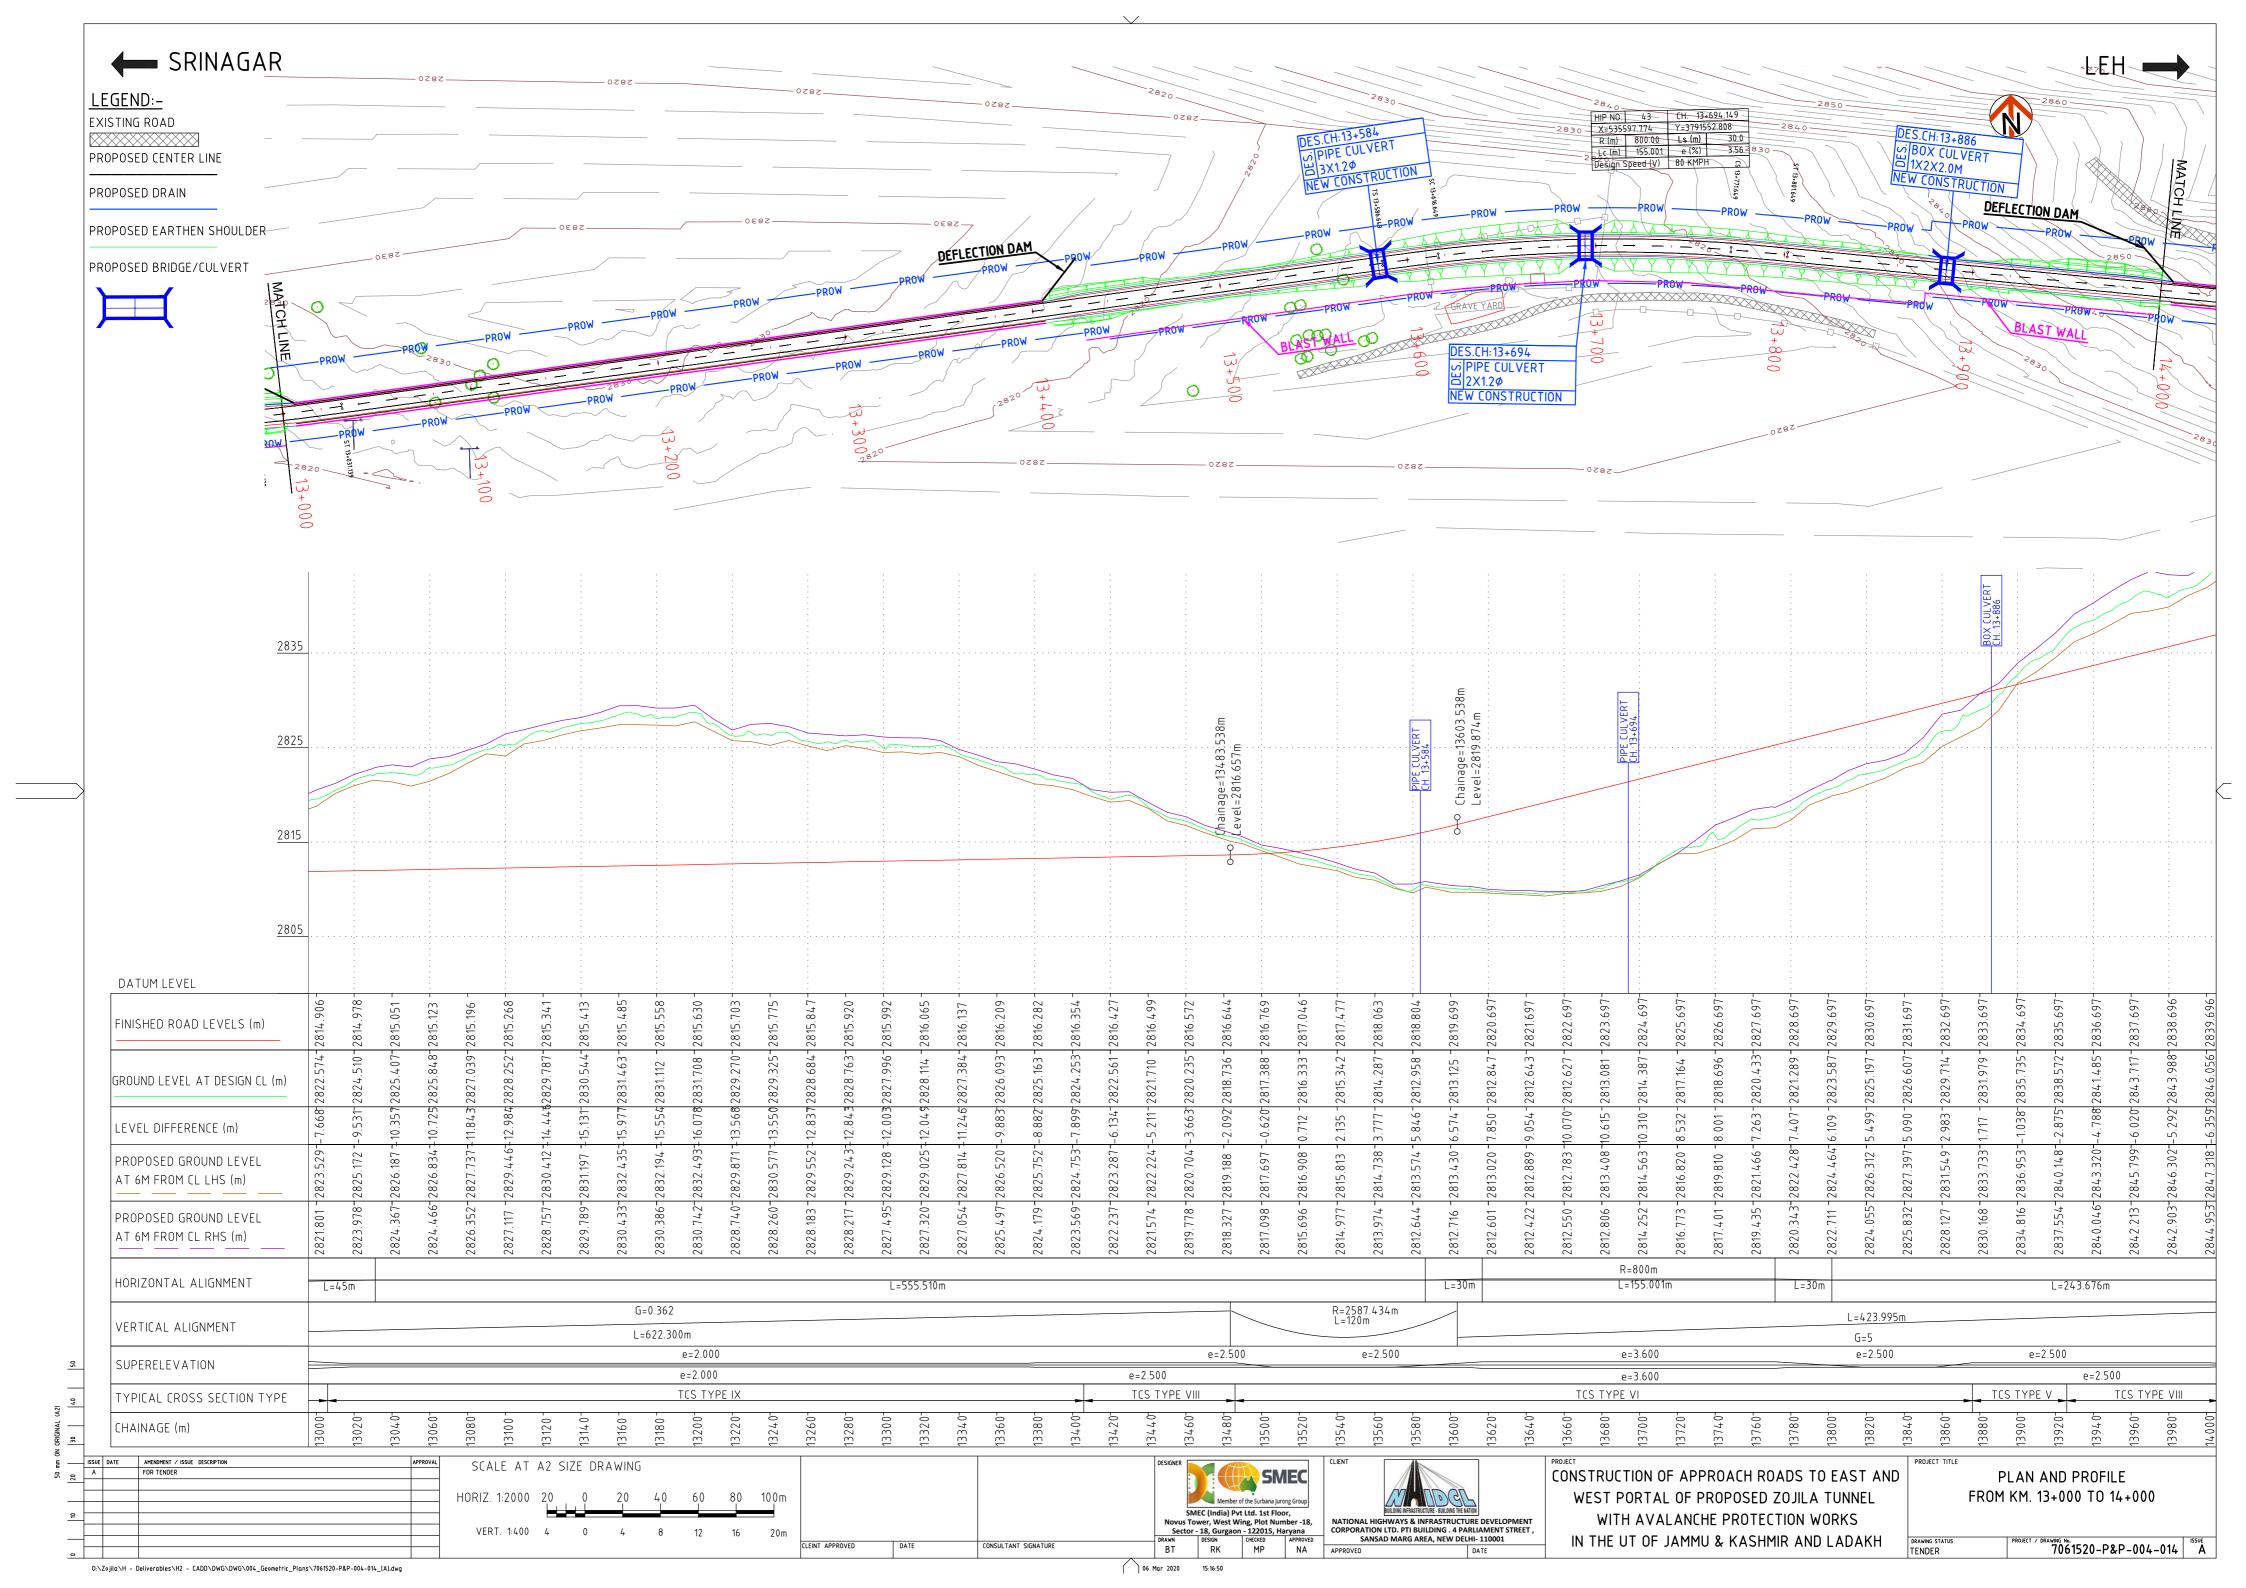


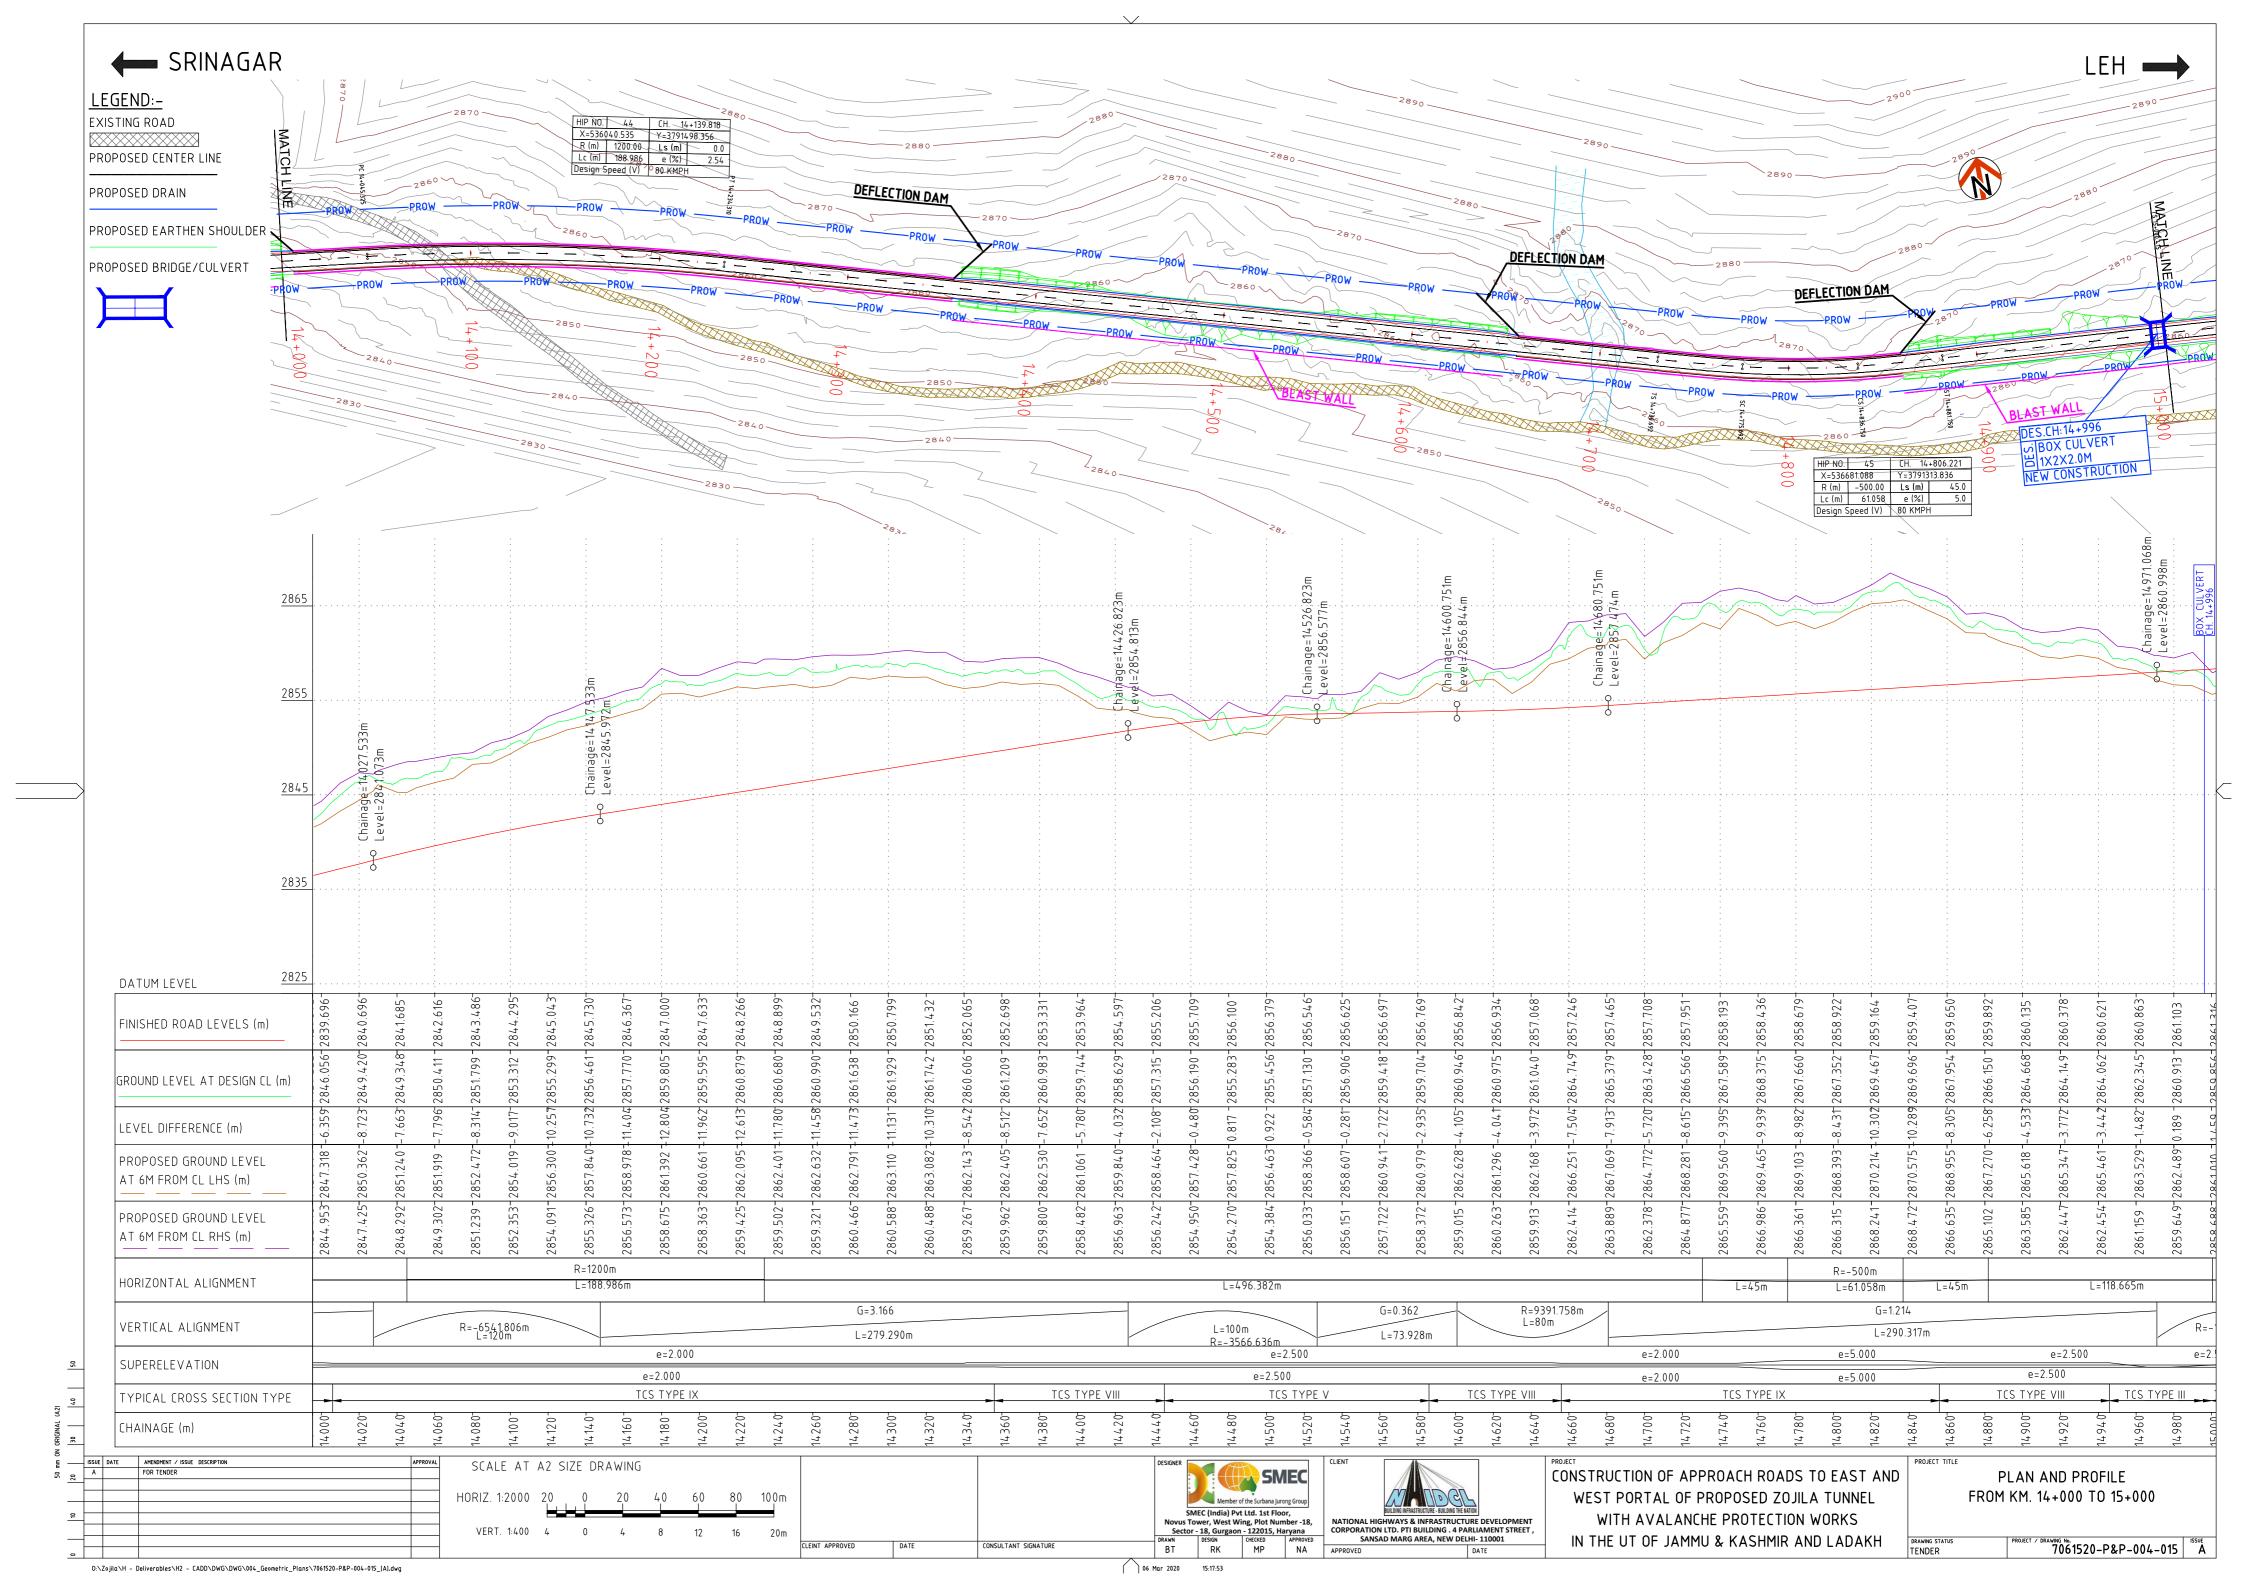

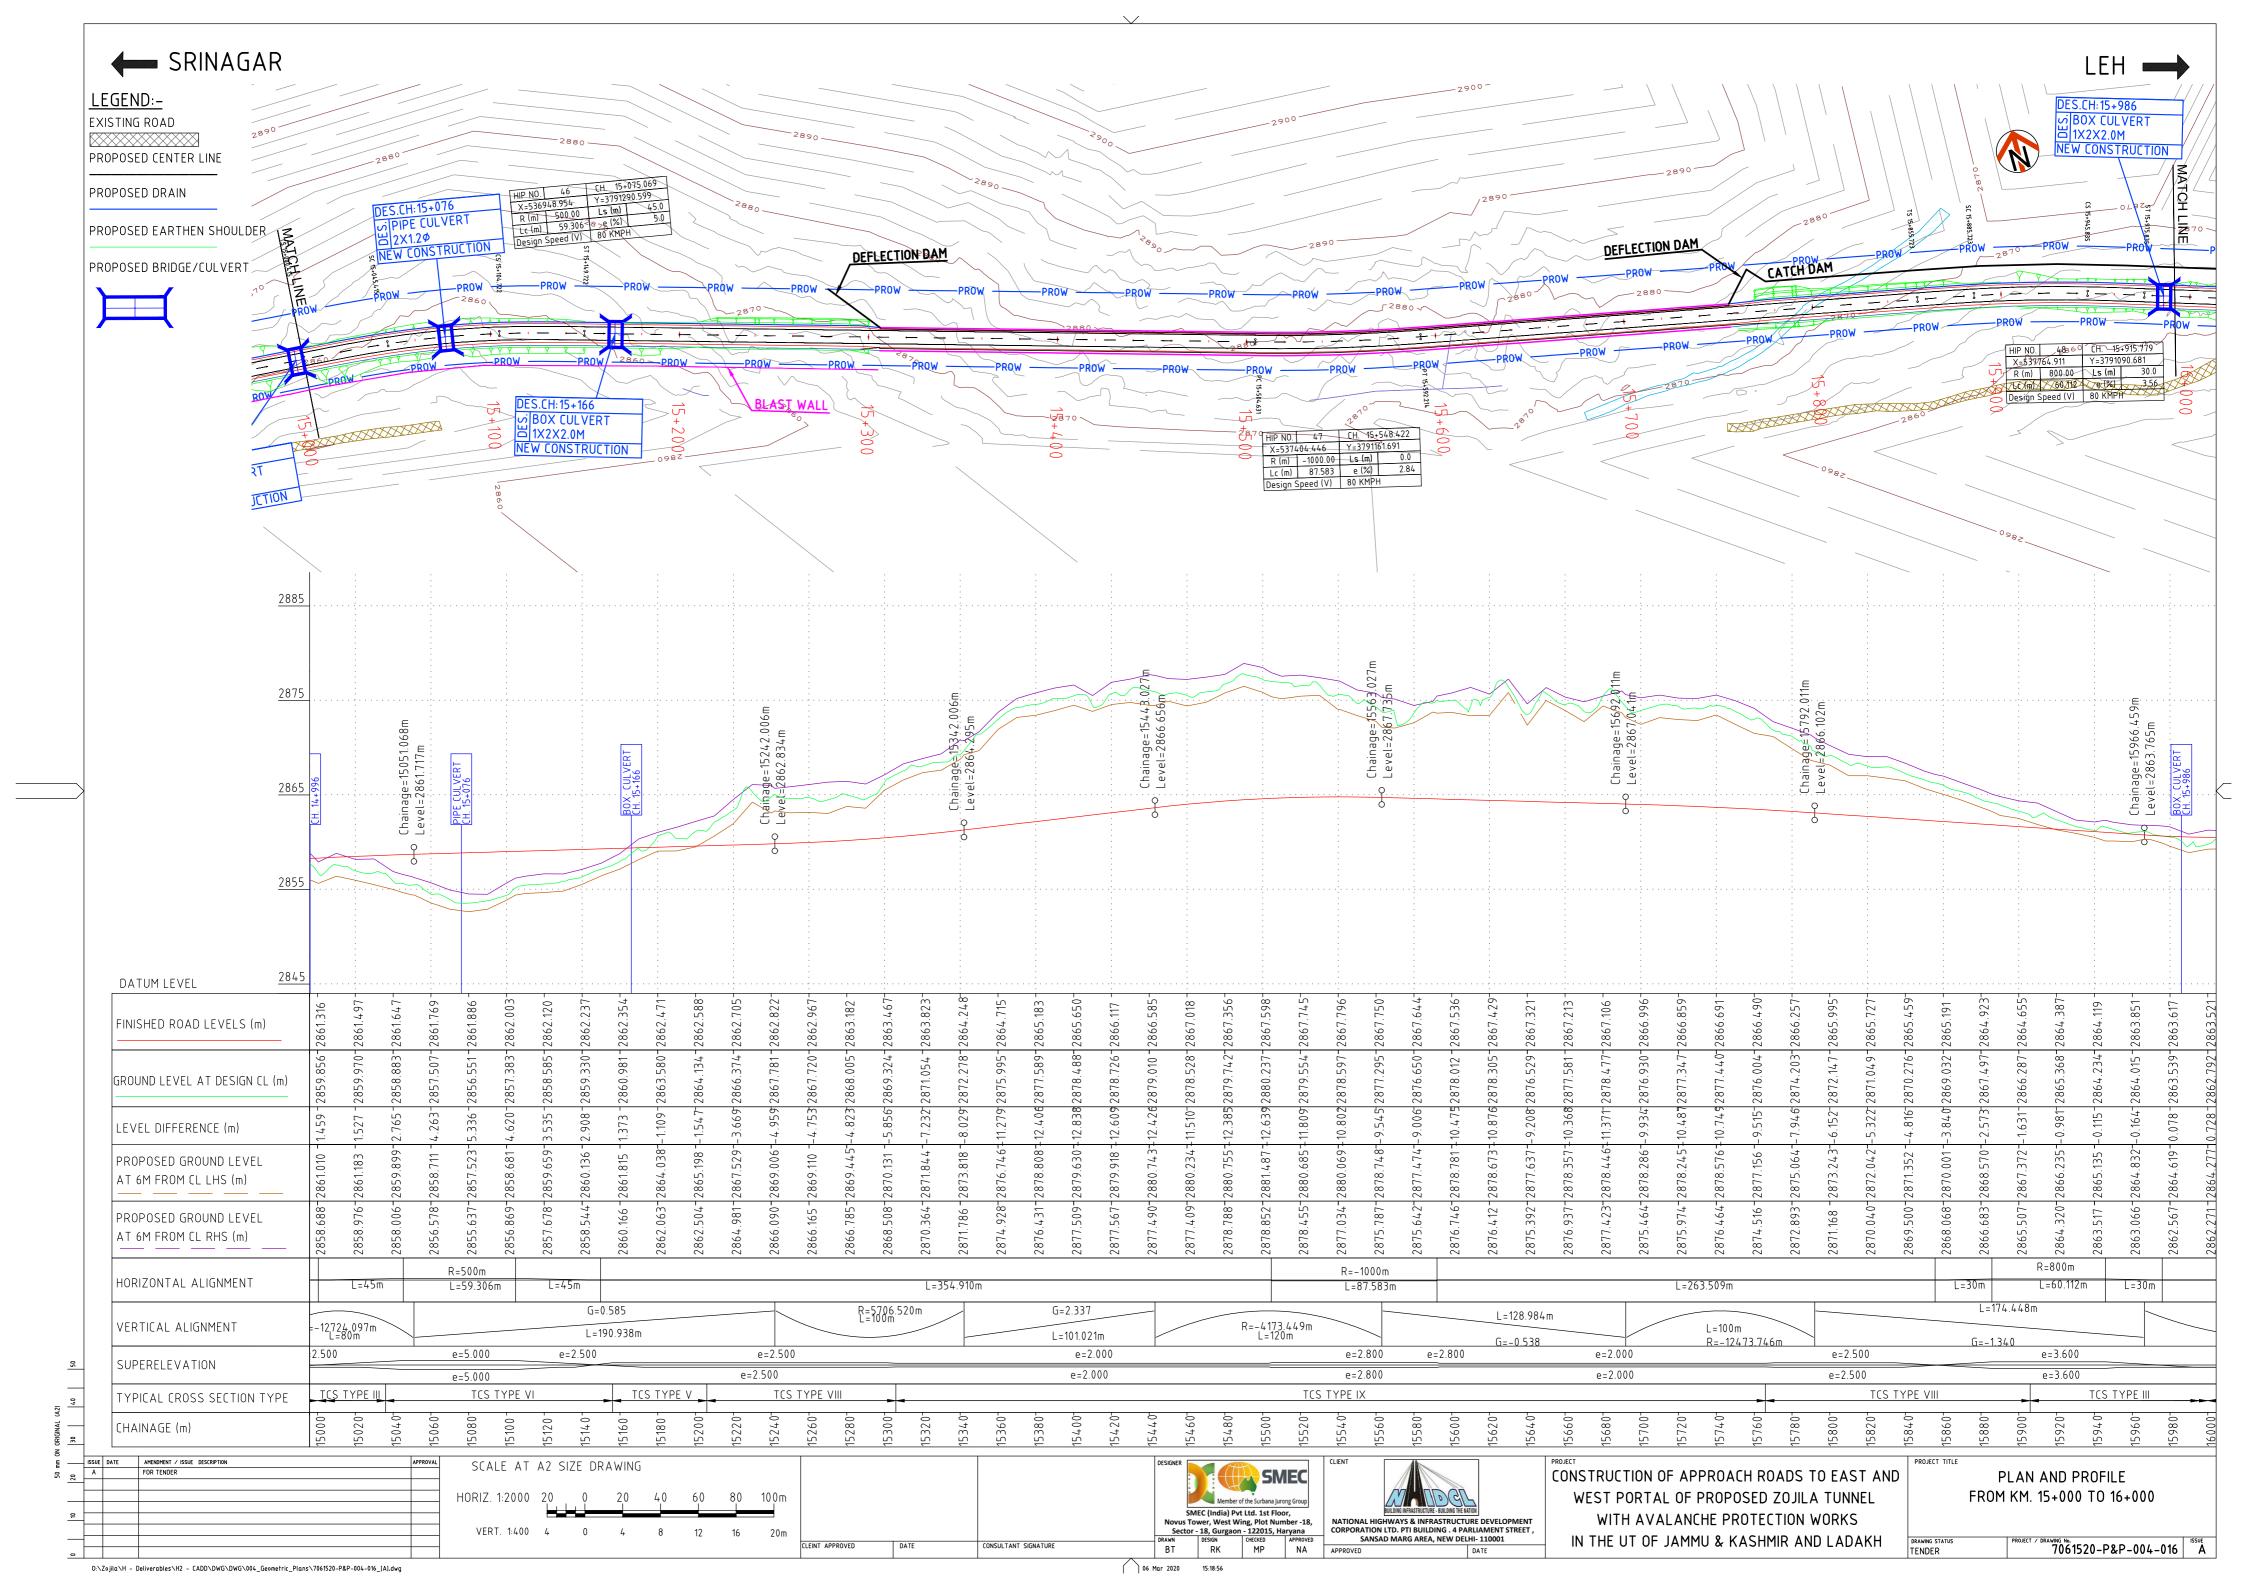

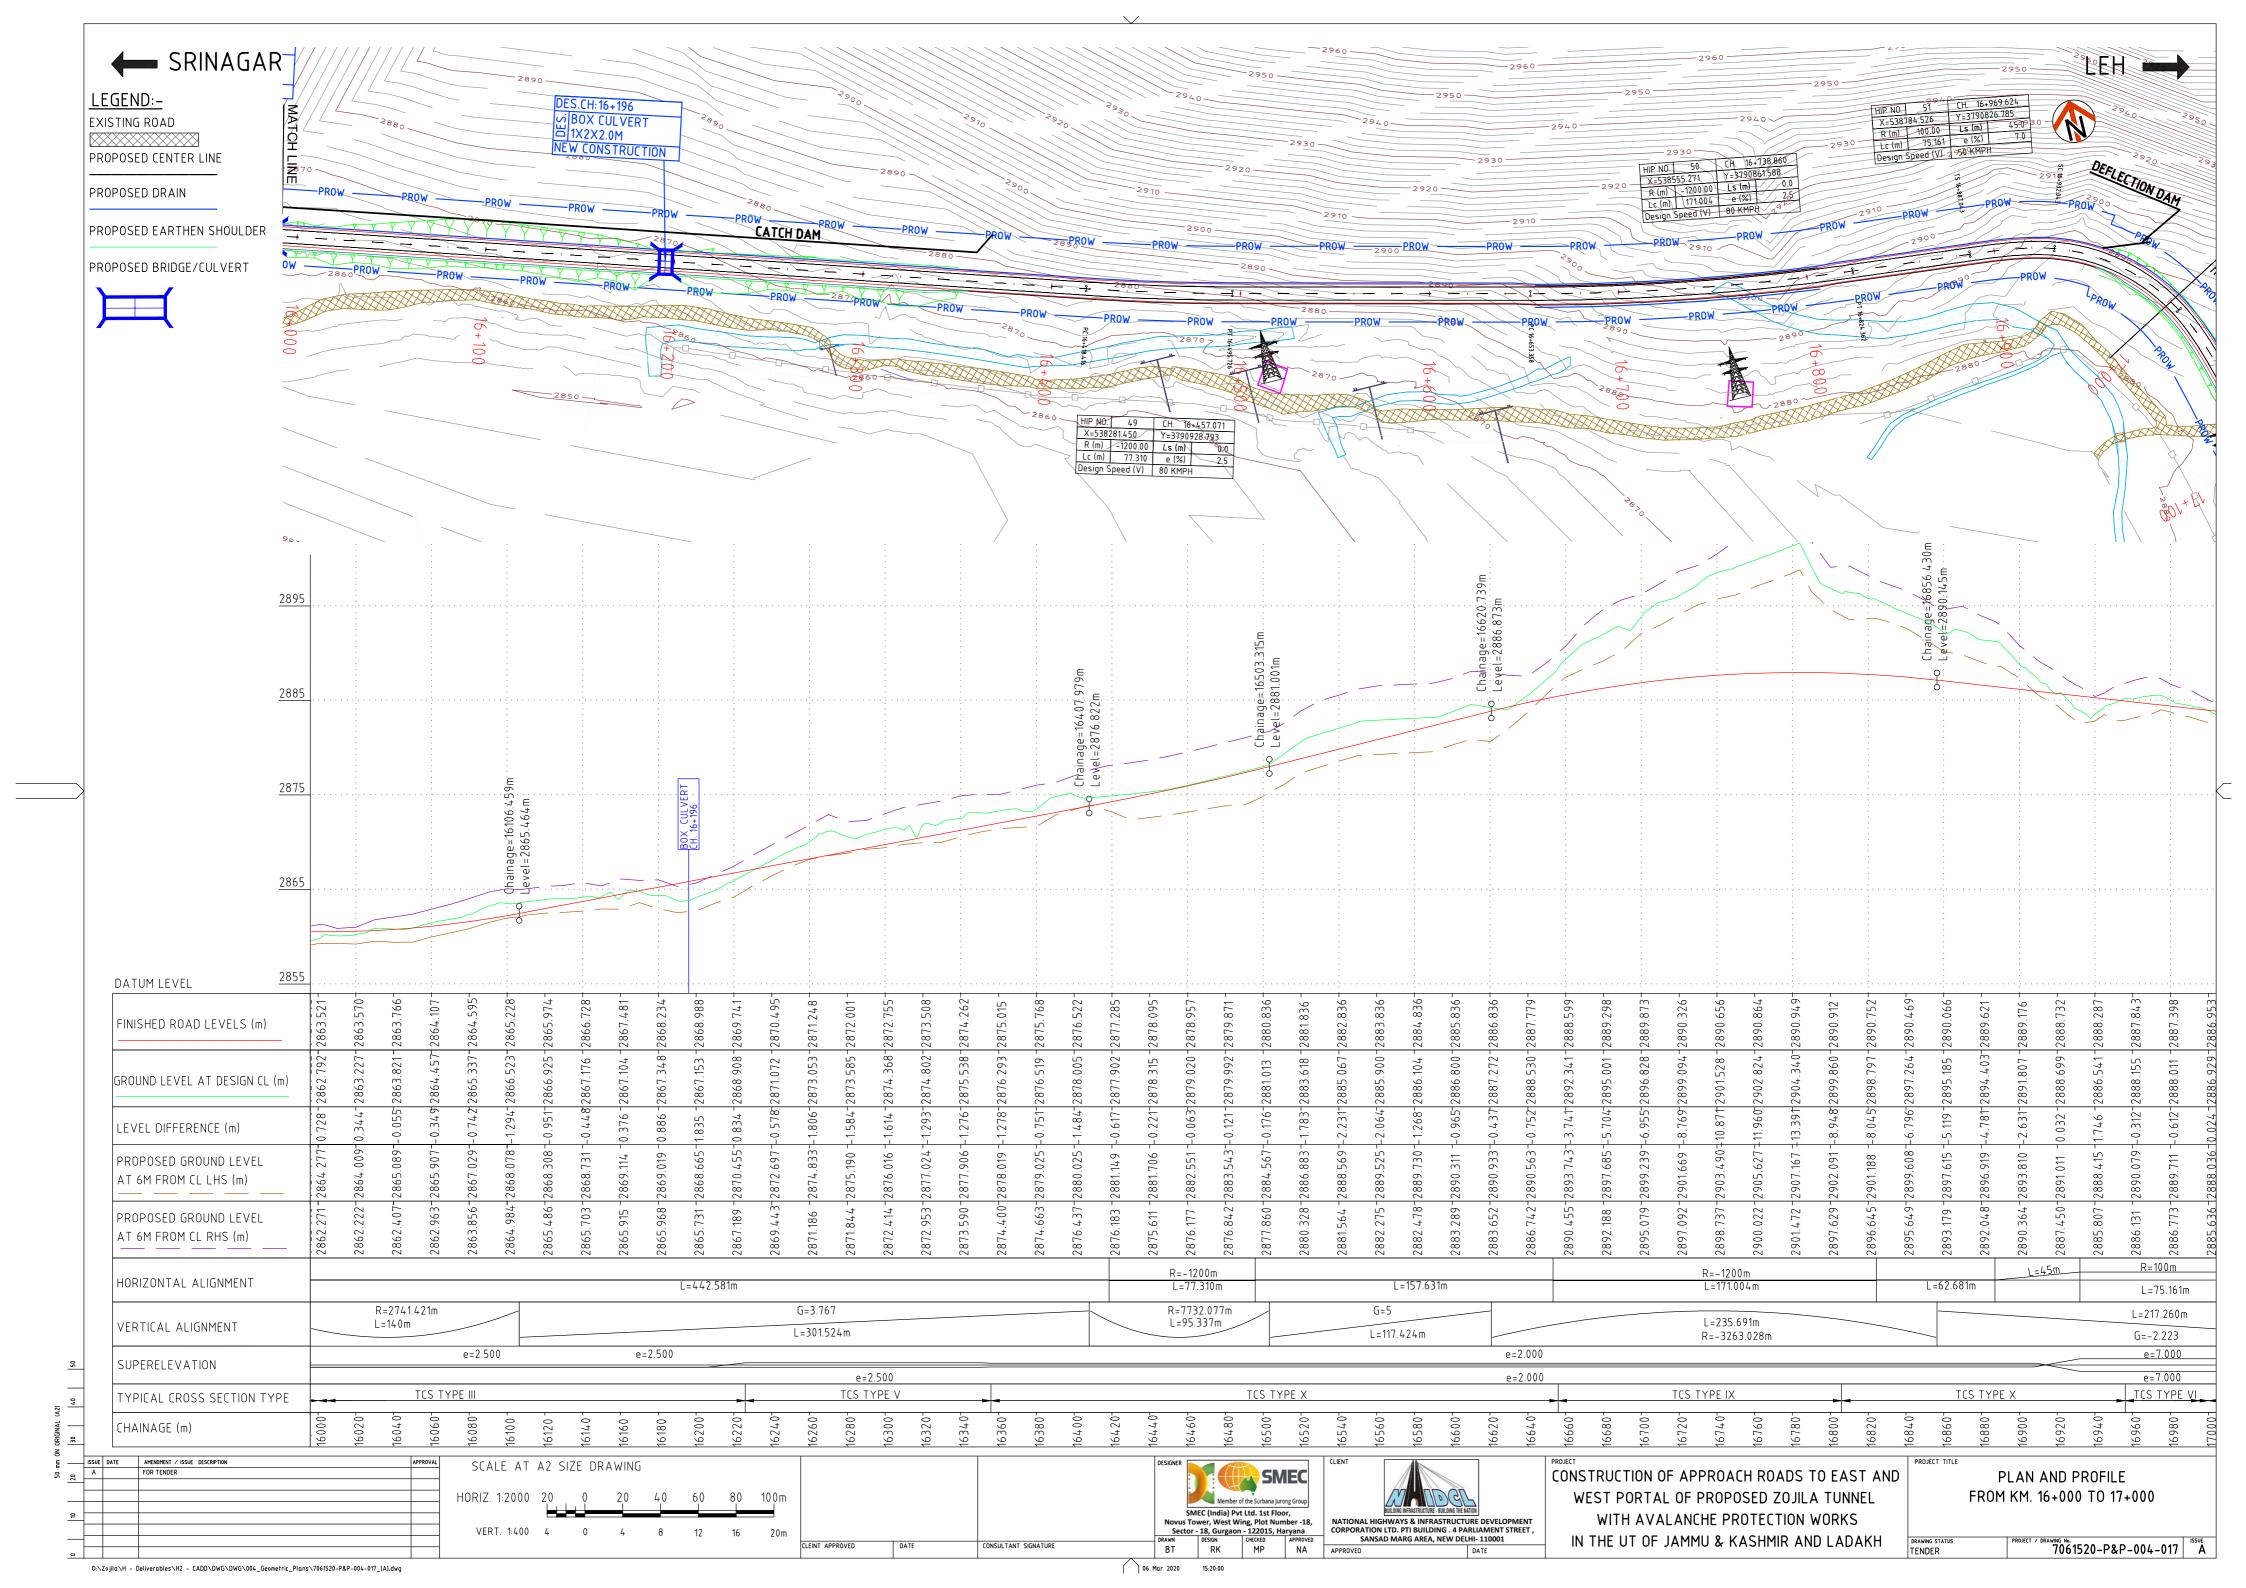

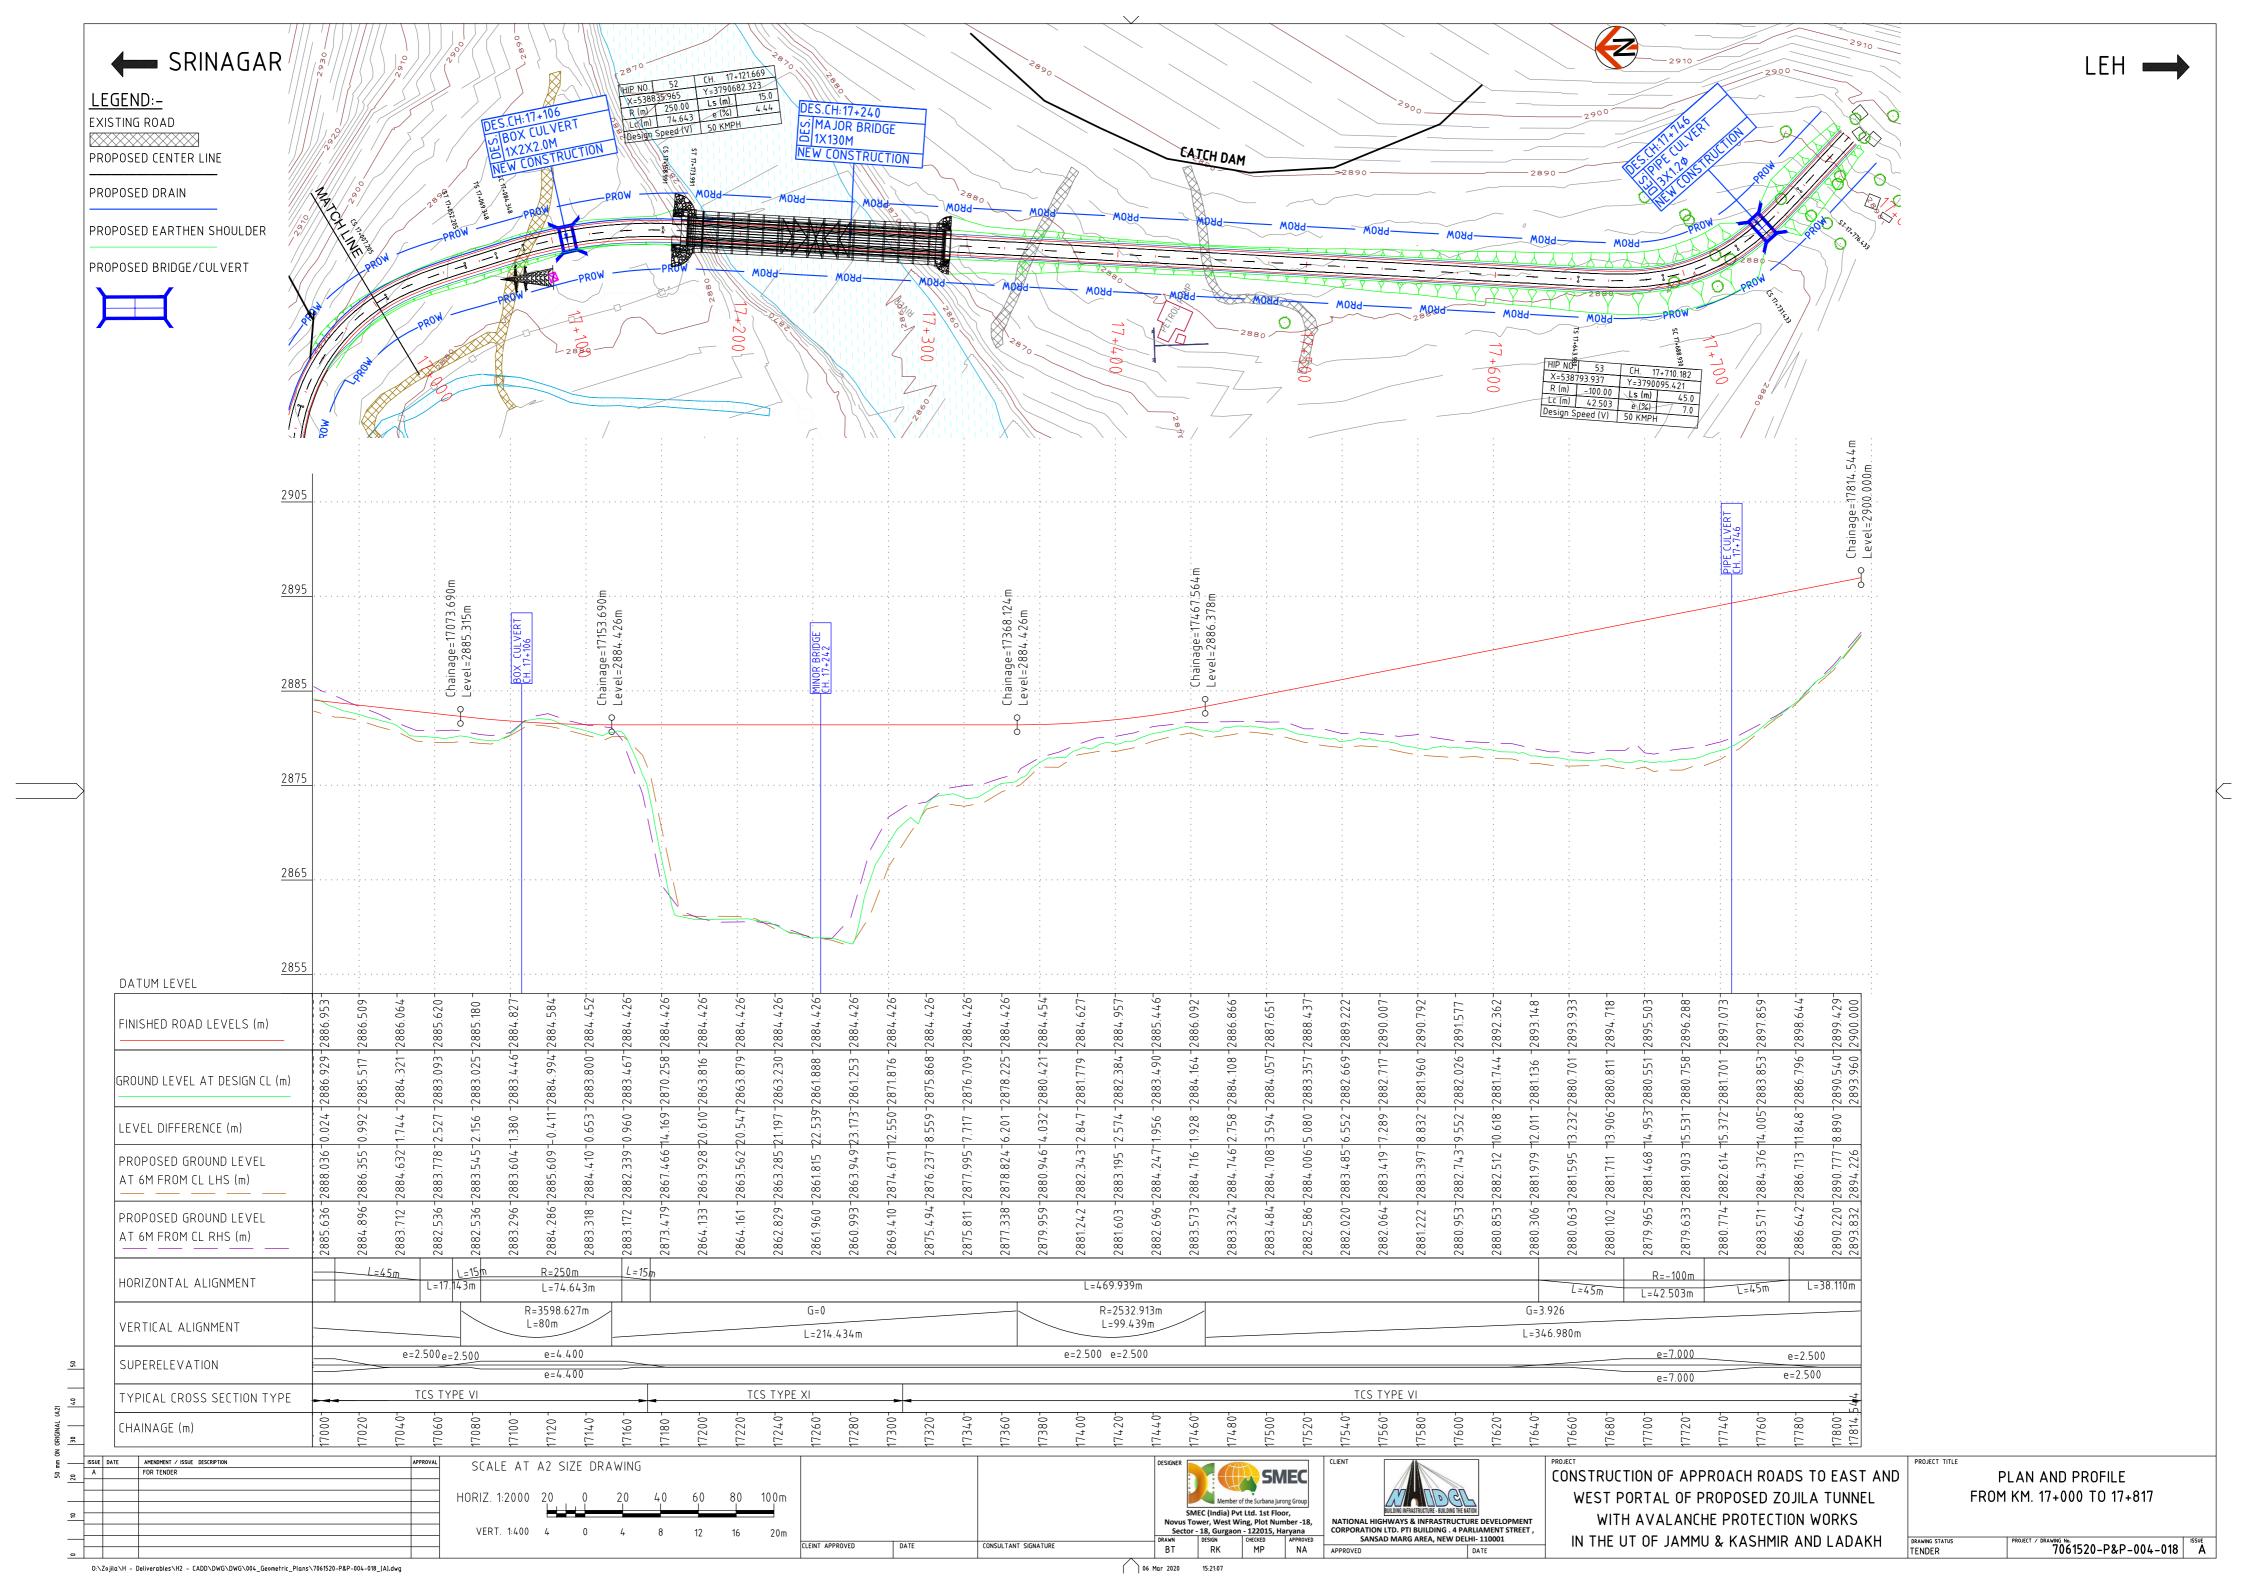

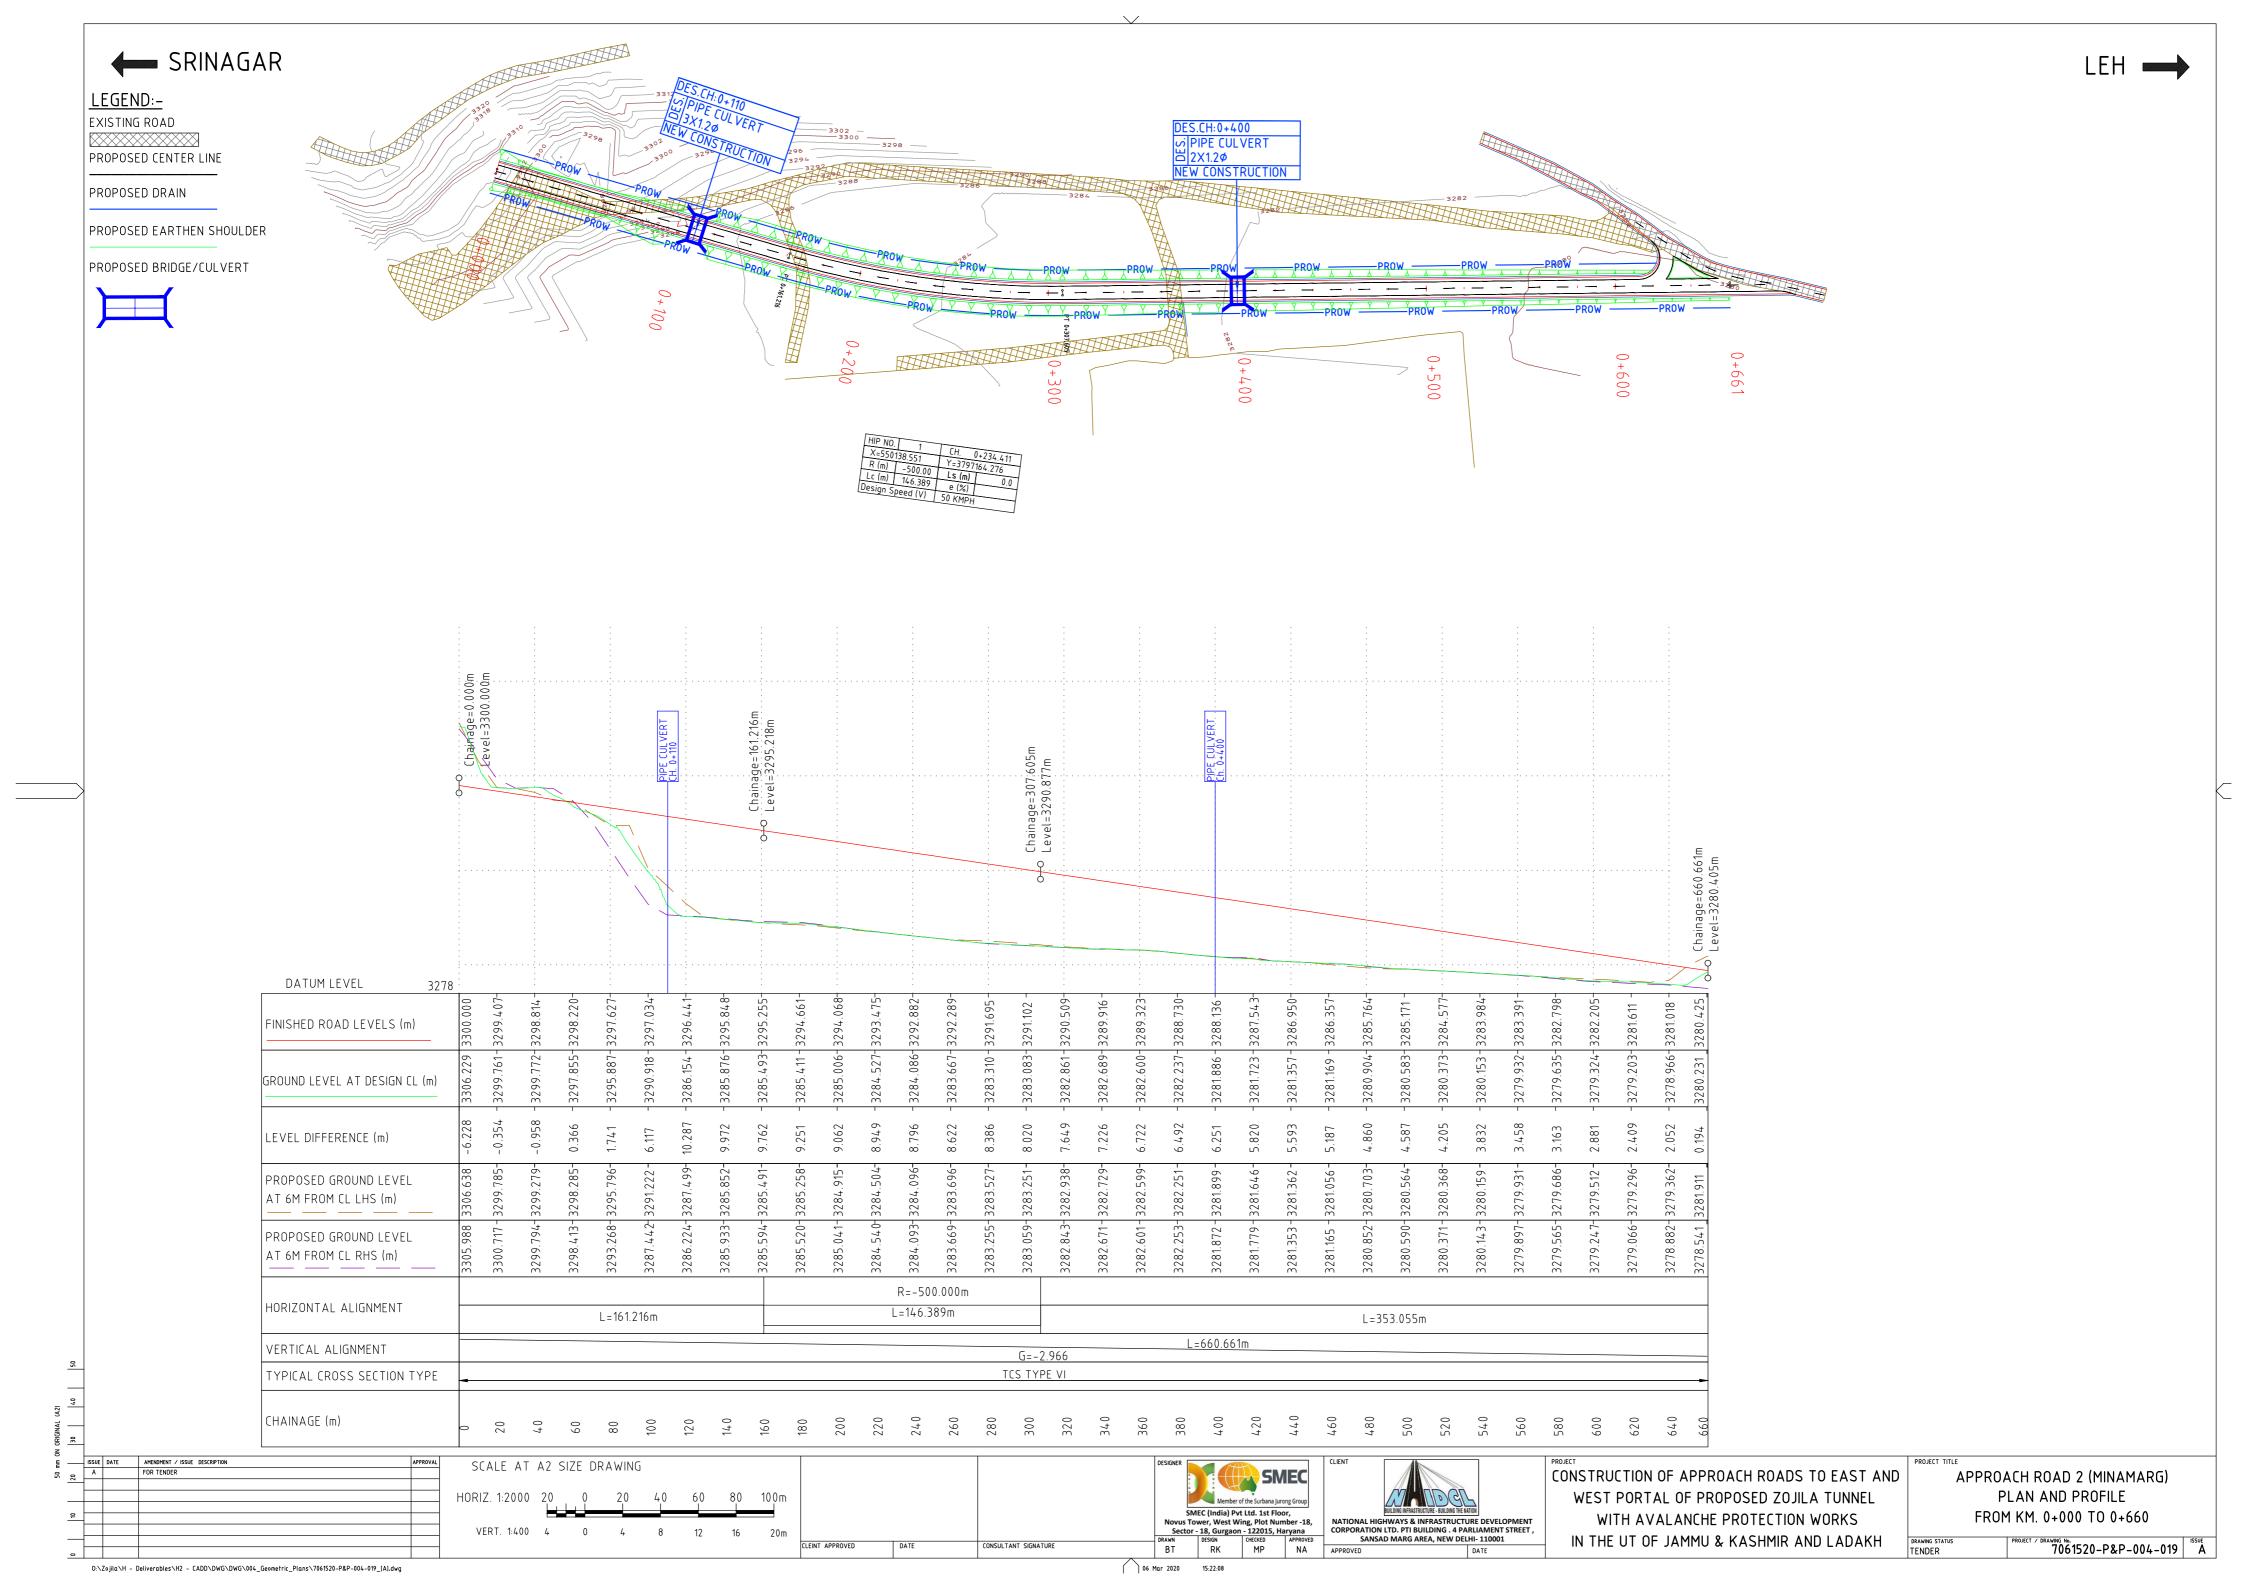

|                 | Chainage       |            |             |        | Φτ                      | Øs                              | Ø Total               | Shift | Ts                | Es                   | Ls                   | Lc            | L Total               | Start of   | Start of     | End of       | End of     |                  |           |
|-----------------|----------------|------------|-------------|--------|-------------------------|---------------------------------|-----------------------|-------|-------------------|----------------------|----------------------|---------------|-----------------------|------------|--------------|--------------|------------|------------------|-----------|
| Curve<br>Number | Lurve   at HIP | Easting    | Northing    | Radius | Deflection angle(curve) | Deflection<br>angle(Transition) | Total Deviation angle | (s)   | Tangent<br>length | External<br>distance | Transition<br>length | Arc<br>length | Total curve<br>length | Transition | Circular arc | Circular arc | Transition | Hand of<br>Curve | Speed (V) |
|                 | (m)            | (m)        | (m)         | (m)    | (Radians)               | (Radians)                       | (Radians)             | (m)   | (m)               | (m)                  | (m)                  | (m)           | (m)                   | (m)        | (m)          | (m)          | (m)        |                  | (Kmph)    |
| 36              | 10604.512      | 532816.397 | 3792502.949 | 500    | 0.380                   | 0.045                           | 0.470                 | 0.169 | 142.156           | 9.145                | 45.000               | 189.819       | 279.819               | 10464.603  | 10509.603    | 10699.421    | 10744.421  | Left             | 80        |
| 37              | 11074.691      | 533285.691 | 3792432.025 | 400    | 0.586                   | 0.069                           | 0.724                 | 0.315 | 179.093           | 17.837               | 55.000               | 234.598       | 344.598               | 10902.392  | 10957.392    | 11191.989    | 11246.989  | Right            | 80        |
| 38              | 11376.518      | 533497.980 | 3792212.500 | 500    | 0.207                   | 0.045                           | 0.297                 | 0.169 | 97.328            | 2.690                | 45.000               | 103.503       | 193.503               | 11279.767  | 11324.767    | 11428.270    | 11473.270  | Left             | 80        |
| 39              | 11834.409      | 533889.548 | 3791973.558 | 800    | 0.278                   | 0.019                           | 0.315                 | 0.047 | 142.130           | 7.773                | 30.000               | 222.137       | 282.137               | 11693.341  | 11723.341    | 11945.478    | 11975.478  | Left             | 80        |
| 40              | 12140.832      | 534187.517 | 3791896.886 | 500    | 0.301                   | 0.045                           | 0.391                 | 0.169 | 121.589           | 5.723                | 45.000               | 150.579       | 240.579               | 12020.543  | 12065.543    | 12216.122    | 12261.122  | Right            | 80        |
| 41              | 12403.458      |            |             | 500    | 0.148                   | 0.045                           | 0.238                 | 0.169 | 82.283            | 1.371                | 45.000               | 73.960        | 163.960               | 12321.478  | 12366.478    | 12440.438    | 12485.438  | Right            | 80        |
| 42              | 12767.286      | 534659.649 | 3791466.676 | 500    | 0.875                   | 0.045                           | 0.965                 | 0.169 | 284.616           | 52.043               | 45.000               | 437.707       | 527.707               | 12503.432  | 12548.432    | 12986.139    | 13031.139  | Left             | 80        |
| 43              | 13694.149      | 535597.774 | 3791552.808 | 800    | 0.194                   | 0.019                           | 0.231                 | 0.047 | 107.920           | 3.769                | 30.000               | 155.001       | 215.001               | 13586.649  | 13616.649    | 13771.649    | 13801.649  | Right            | 80        |
| 44              | 14139.818      | 536040.535 | 3791498.356 | 1200   | 0.157                   |                                 | 0.195                 | 0.000 | 132.368           | 3.730                |                      | 188.986       | 188.986               |            | 14045.325    | 14234.310    |            | Right            | 80        |
| 45              | 14806.221      | 536681.088 | 3791313.836 | 500    | 0.122                   | 0.045                           | 0.212                 | 0.169 | 75.746            | 0.933                | 45.000               | 61.058        | 151.058               | 14730.692  | 14775.692    | 14836.750    | 14881.750  | Left             | 80        |
| 46              | 15075.069      | 536948.954 | 3791290.599 | 500    | 0.119                   | 0.045                           | 0.209                 | 0.169 | 74.861            | 0.881                | 45.000               | 59.306        | 149.306               | 15000.415  | 15045.415    | 15104.722    | 15149.722  | Right            | 80        |
| 47              | 15548.422      | 537404.446 | 3791161.691 | 1000   | 0.088                   |                                 | 0.178                 | 0.000 | 111.533           | 0.960                |                      | 87.583        | 87.583                |            | 15504.631    | 15592.214    |            | Left             | 80        |
| 48              | 15915.779      | 537764.911 | 3791090.681 | 800    | 0.075                   | 0.019                           | 0.113                 | 0.047 | 60.106            | 0.565                | 30.000               | 60.112        | 120.112               | 15855.723  | 15885.723    | 15945.835    | 15975.835  | Right            | 80        |
| 49              | 16457.071      | 538281.450 | 3790928.793 | 1200   | 0.064                   |                                 | 0.102                 | 0.000 | 76.210            | 0.623                |                      | 77.310        | 77.310                |            | 16418.416    | 16495.726    |            | Left             | 80        |
| 50              | 16738.860      | 538555.271 | 3790861.588 | 1200   | 0.143                   |                                 | 0.180                 | 0.000 | 123.298           | 3.053                |                      | 171.004       | 171.004               |            | 16653.358    | 16824.362    |            | Left             | 80        |
| 51              | 16969.624      | 538784.526 | 3790826.785 | 100    | 0.752                   | 0.225                           | 1.202                 | 0.844 | 91.610            | 7.502                | 45.000               | 75.161        | 165.161               | 16887.043  | 16932.043    | 17007.205    | 17052.205  | Right            | 50        |
| 52              | 17121.669      | 538835.965 | 3790682.323 | 250    | 0.299                   | 0.030                           | 0.359                 | 0.038 | 52.815            | 2.812                | 15.000               | 74.643        | 104.643               | 17069.348  | 17084.348    | 17158.991    | 17173.991  | Right            | 50        |
| 53              | 17710.182      | 538793.937 | 3790095.421 | 100    | 0.425                   | 0.225                           | 0.875                 | 0.844 | 69.670            | 2.301                | 45.000               | 42.503        | 132.503               | 17643.930  | 17688.930    | 17731.433    | 17776.433  | Left             | 50        |

### APPORACH ROAD TO (MINAMARG)

|       | Chain | 200          |             |        | Фс                      | Øς                              | ØTotal                |           | Ts             | Es                | Ls                | Lc         | L Total            |                     |                       |                     |                   |               |           |
|-------|-------|--------------|-------------|--------|-------------------------|---------------------------------|-----------------------|-----------|----------------|-------------------|-------------------|------------|--------------------|---------------------|-----------------------|---------------------|-------------------|---------------|-----------|
| Curve |       | ege Easting  | Northing    | Radius | Deflection angle(curve) | Deflection<br>angle(Transition) | Total Deviation angle | Shift (s) | Tangent length | External distance | Transition length | Arc length | Total curve length | Start of Transition | Start of Circular arc | End of Circular arc | End of Transition | Hand of Curve | Speed (V) |
| Numbe | (m)   | (m)          | (m)         | (m)    | (Radians)               | (Radians)                       | (Radians)             | (m)       | (m)            | (m)               | (m)               | (m)        | (m)                | (m)                 | (m)                   | (m)                 | (m)               |               | (Kmph)    |
| 1     | 234.4 | 11 550138.55 | 3797164.276 | 500    | 0.293                   |                                 | 0.293                 | 0.000     | 73.722         | 5.406             |                   | 146.389    | 146.389            |                     | 161.216               | 307.605             |                   | Left          | 50        |

DESIDES SINCE (India) PROVED DATE

CONSECUTION DE APPROACH ROADS TO EAST AND WEST PORTAL OF PROPOSED ZOJILA TUNNEL WITH AVALANCHE PROTECTION WORKS IN THE UT OF JAMMU & KASHMIR AND LADAKH

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| Curve<br>Number | Chainage at<br>PVI | Level of PVI | Length of curve | Type of | Grade<br>IN | Grade<br>OUT | Grade<br>Difference | Radius    | Chaina         | ge (m)       | Leve           | K Value      |         |
|-----------------|--------------------|--------------|-----------------|---------|-------------|--------------|---------------------|-----------|----------------|--------------|----------------|--------------|---------|
|                 | (m)                | (m)          | (m)             | curve   | %           | % %          | %                   | (m)       | Start of curve | End of curve | Start of curve | End of curve | r value |
| 44              | 9745.020           | 2766.564     | 120.000         | Hog     | 5.000       | 1.380        | -3.620              | 3314.915  | 9685.020       | 9805.020     | 2763.564       | 2767.392     | 33.149  |
| 45              | 10108.894          | 2771.585     | 80.000          | Sag     | 1.380       | 3.330        | 1.951               | 4101.300  | 10068.894      | 10148.894    | 2771.033       | 2772.917     | 41.005  |
| 46              | 10305.923          | 2778.147     | 100.000         | Hog     | 3.330       | 0.783        | -2.547              | 3925.658  | 10255.923      | 10355.923    | 2776.482       | 2778.539     | 39.262  |
| 47              | 10690.661          | 2781.160     | 120.000         | Sag     | 0.783       | 4.172        | 3.389               | 3540.860  | 10630.661      | 10750.661    | 2780.690       | 2783.663     | 35.409  |
| 48              | 11129.333          | 2799.462     | 120.000         | Hog     | 4.172       | 0.531        | -3.641              | 3295.952  | 11069.333      | 11189.333    | 2796.959       | 2799.781     | 32.958  |
| 49              | 11558.463          | 2801.742     | 150.000         | Hog     | 0.531       | -4.596       | -5.128              | 2925.295  | 11483.463      | 11633.463    | 2801.344       | 2798.295     | 29.251  |
| 50              | 11853.543          | 2788.179     | 150.000         | Sag     | -4.596      | 1.279        | 5.876               | 2552.958  | 11778.543      | 11928.543    | 2791.626       | 2789.138     | 25.528  |
| 51              | 12395.228          | 2795.108     | 100.000         | Sag     | 1.279       | 4.924        | 3.645               | 2743.823  | 12345.228      | 12445.228    | 2794.468       | 2797.570     | 27.435  |
| 52              | 12781.238          | 2814.114     | 160.000         | Hog     | 4.924       | 0.362        | -4.562              | 3507.507  | 12701.238      | 12861.238    | 2810.175       | 2814.404     | 35.072  |
| 53              | 13543.538          | 2816.874     | 120.000         | Sag     | 0.362       | 5.000        | 4.638               | 2587.434  | 13483.538      | 13603.538    | 2816.657       | 2819.874     | 25.873  |
| 54              | 14087.533          | 2844.073     | 120.000         | Hog     | 5.000       | 3.166        | -1.834              | 6541.806  | 14027.533      | 14147.533    | 2841.073       | 2845.972     | 65.431  |
| 55              | 14476.823          | 2856.396     | 100.000         | Hog     | 3.166       | 0.362        | -2.804              | 3566.636  | 14426.823      | 14526.823    | 2854.813       | 2856.577     | 35.663  |
| 56              | 14640.751          | 2856.989     | 80.000          | Sag     | 0.362       | 1.214        | 0.852               | 9391.758  | 14600.751      | 14680.751    | 2856.844       | 2857.474     | 93.897  |
| 57              | 15011.068          | 2861.483     | 80.000          | Hog     | 1.214       | 0.585        | -0.629              | 12724.097 | 14971.068      | 15051.068    | 2860.998       | 2861.717     | 127.186 |
| 58              | 15292.006          | 2863.126     | 100.000         | Sag     | 0.585       | 2.337        | 1.752               | 5706.520  | 15242.006      | 15342.006    | 2862.834       | 2864.295     | 57.078  |
| 59              | 15503.027          | 2868.058     | 120.000         | Hog     | 2.337       | -0.538       | -2.875              | 4173.449  | 15443.027      | 15563.027    | 2866.656       | 2867.735     | 41.739  |
| 60              | 15742.011          | 2866.772     | 100.000         | Hog     | -0.538      | -1.340       | -0.802              | 12473.744 | 15692.011      | 15792.011    | 2867.041       | 2866.102     | 124.688 |
| 61              | 16036.455          | 2862.827     | 140.000         | Sag     | -1.340      | 3.767        | 5.107               | 2741.445  | 15966.455      | 16106.455    | 2863.765       | 2865.464     | 27.413  |
| 62              | 16455.647          | 2878.618     | 95.000          | Sag     | 3.767       | 5.000        | 1.233               | 7704.785  | 16408.147      | 16503.147    | 2876.829       | 2880.993     | 77.048  |
| 63              | 16738.584          | 2892.765     | 235.000         | Hog     | 5.000       | -2.223       | -7.223              | 3253.464  | 16621.084      | 16856.084    | 2886.890       | 2890.153     | 32.535  |
| 64              | 17113.690          | 2884.426     | 80.000          | Sag     | -2.223      | 0.000        | 2.223               | 3598.627  | 17073.690      | 17153.690    | 2885.315       | 2884.426     | 35.987  |
| 65              | 17417.844          | 2884.426     | 100.000         | Sag     | 0.000       | 3.926        | 3.926               | 2547.193  | 17367.844      | 17467.844    | 2884.426       | 2886.389     | 25.471  |

ISSUE DATE AMENDMENT / ISSUE DESCRIPTION
A FOR TENDER  $0: \label{localization} 0: \label{localization} O: \$ 

CLEINT APPROVED CONSULTANT SIGNATURE

SMEC

SMEC (India) Pvt Ltd. 1st Floor,
Novus Tower, West Wing, Plot Number -18,
Sector - 18, Gurgaon - 122015, Haryana

DRAWN DESIGN CHECKED APPROVED
BT RK MP NA PROVED

BANSAD MARG AREA, NEW DELHI- 110001

APPROVED DATE

CONSTRUCTION OF APPROACH ROADS TO EAST AND WEST PORTAL OF PROPOSED ZOJILA TUNNEL WITH AVALANCHE PROTECTION WORKS IN THE UT OF JAMMU & KASHMIR AND LADAKH

VERTICAL ALIGNMENT REPORT

7061520-P&P-004-021B A